


VICINITY MAP SCALE: N.T.S.

LINCOLN AVENUE

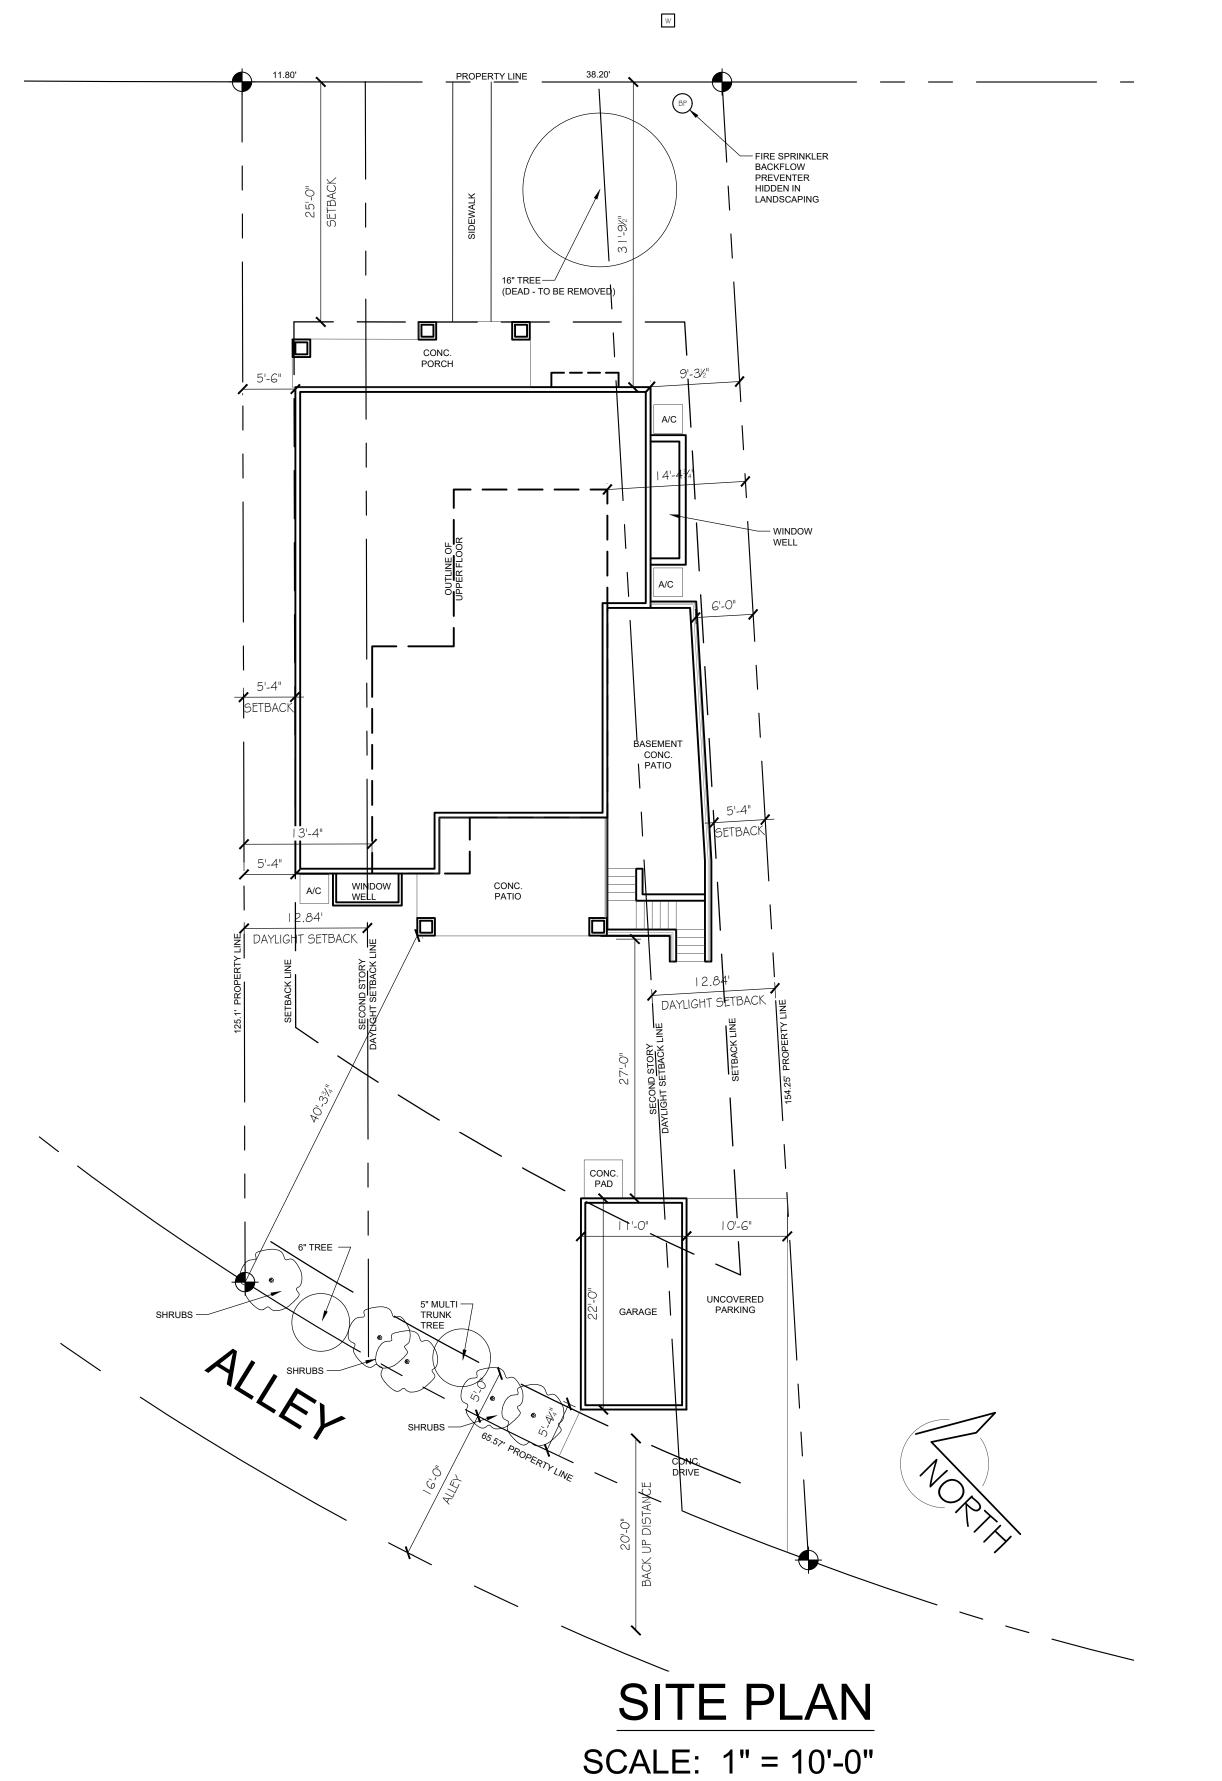

SHEET INDEX

ARCHITECTURAL GENERAL SHEETS G1.0 COVER & SITE PLAN

G1.1 NEIGHBORHOOD CONTEXT MAP

G1.2 FLOOR AREA COVERAGE DIAGRAM

GRADING AND DRAINAGE PLAN C1

C2 GRADING AND DRAINAGE DETAILS
C3 EROSION CONTROL PLAN

BOUNDARY AND TOPOGRAPHICAL MAP BOUNDARY AND TOPOGRAPHICAL MAP

LANDSCAPE

L-1 LANDSCAPING PLAN L-2 TREE PROTECTION PLAN

ARCHITECTURAL PLANS

A2.0 MAIN & UPPER FLOOR PLANS A2.1 FOUNDATION/BASEMENT & ROOF PLANS

A3.0A ELEVATIONS - OPTION 1 A3.0B ELEVATIONS - OPTION 1

A3.1A ELEVATIONS - OPTION 2 A3.1B ELEVATIONS - OPTION 2

A4.0 GARAGE PLANS & ELEVATIONS

A6.0 BUILDING SECTIONS & DETAILS

PROJECT DESCRIPTION

CONSTRUCTION OF A NEW TWO-STORY RESIDENCE WITH BASEMENT AND DETACHED GARAGE ON A SINGLE FAMILY ZONED LOT WITHIN LOS ALTOS CITY LIMITS. EXISTING STRUCTURE ON THE PROPERTY TO BE DEMOLISHED UNDER A SEPARATE PERMIT. WORK TO INCLUDE PROTECTION OF EXISTING LANDSCAPING, NEW FIRE-SPRINKLERED RESIDENCE, AND NEW LANDSCAPING.

DESIGN TEAM

ARCHITECTURAL

LANDSCAPE

GREG BAER

JULIE BENINTENDI

1508 S BIGGS ST BOISE, ID 83709 208.869.4971

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117 BERNAL RD, STE. 70-336

OSUNAENGINEERING@GMAIL.COM

JULIEBENINTENDI@YAHOO.COM

LEGAL DESCRIPTION

LOT SIZE: 7,592 SQ FT / 0.18 ACRES

ADDRESS: 566 LINCOLN AVE, LOS ALTOS, CA

PARCEL NO. 175-16-083, LOS ALTOS, SANTA CLARA COUNTY, CALIFORNIA

70NING COMPLIANCE

ZONING COMI LIANCE				
	Existing	Proposed	Allowed/Required	
LOT COVERAGE:	1632 square feet	2275 square feet	2277 square feet	
	(21.5 %)	(29.9 %)	(30 %)	
FLOOR AREA	1st FIr: 1522 sq. ft.	1st FIr: 1900 sq. ft.	1st Flr: - sq. ft	
	2nd FIr: 0 sq. ft.	2nd FIr: 756 sq. ft.	2nd Flr: - sq. ft.	
	Total: 1522 sq. ft.	Total: 2656 sq. ft.	Total: 2657 sq. ft.	
	(20.0 %)	(34.98 %)	(35%)	
SETBACKS: Front Rear Right Side (1st/2nd) Left Side (1st/2nd)	28 feet	25.0 feet	25 feet	
	49 feet	40.0 feet	25 feet	
	11 feet/ 6 feet	5.34 feet/ 13.34 feet	5.34 feet/ 12.84 feet	
	5 feet/ 0 feet	9.29 feet/ 14.42 feet	5.34 feet/ 12.84 feet	
HEIGHT:	16.75 feet	24.46 feet	27 feet	

SQUARE FOOTAGE BREAKDOWN

		Existing	Change In	Total Proposed
	HABITABLE LIVING AREA:	1082 square feet	3005 square feet	4087 square feet
	NON-HABITABLE LIVING AREA:	440 square feet	-209 square feet	231 square feet

LOT CALCULATIONS

NET LOT AREA:		7592 square feet	
FRONT YARD HARDSCAPE AREA:		100 square feet	
LANDSCAPING BREAKDOWN:	Total hardscape area (existing and proposed): Existing softscape (undisturbed) area: New softscape (new or replaced landscaping) area:		1121 square feet 1075 square feet 3119 square feet

GENERAL SITE NOTES

A. CONTRACTOR TO FIELD VERIFY ALL DIMENSIONS AND SITE REQUIREMENTS. RESOLVE ALL DISCREPANCIES PRIOR TO CONSTRUCTION.

B. FIELD VERIFY ALL BUILDING SETBACKS AND EASEMENTS ARE MET PRIOR TO FOUNDATION POUR.

C. ALL PUBLIC UTILITIES EXISTING OR AVAILABLE PER SUBDIVISION PLAT WITHIN UTILITY EASEMENT.

D. SEE GENERAL NOTES FOR CONSTRUCTION.

E. ALL EXISTING TREES AND LANDSCAPING SCHEDULED TO REMAIN SHALL BE PROTECTED DURING CONSTRUCTION.

BUILDING SETBACK LOT CORNER **NEW BUILDING**

PLANTS & TREES - SEE LANDSCAPE SCHEDULES


BENINTENDI DESIGNER

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REVISIONS:

7/1/18

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LOCATION OF SECOND STORY ROOF OUTLINES

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NEIGHBORHOOD CONTEXT

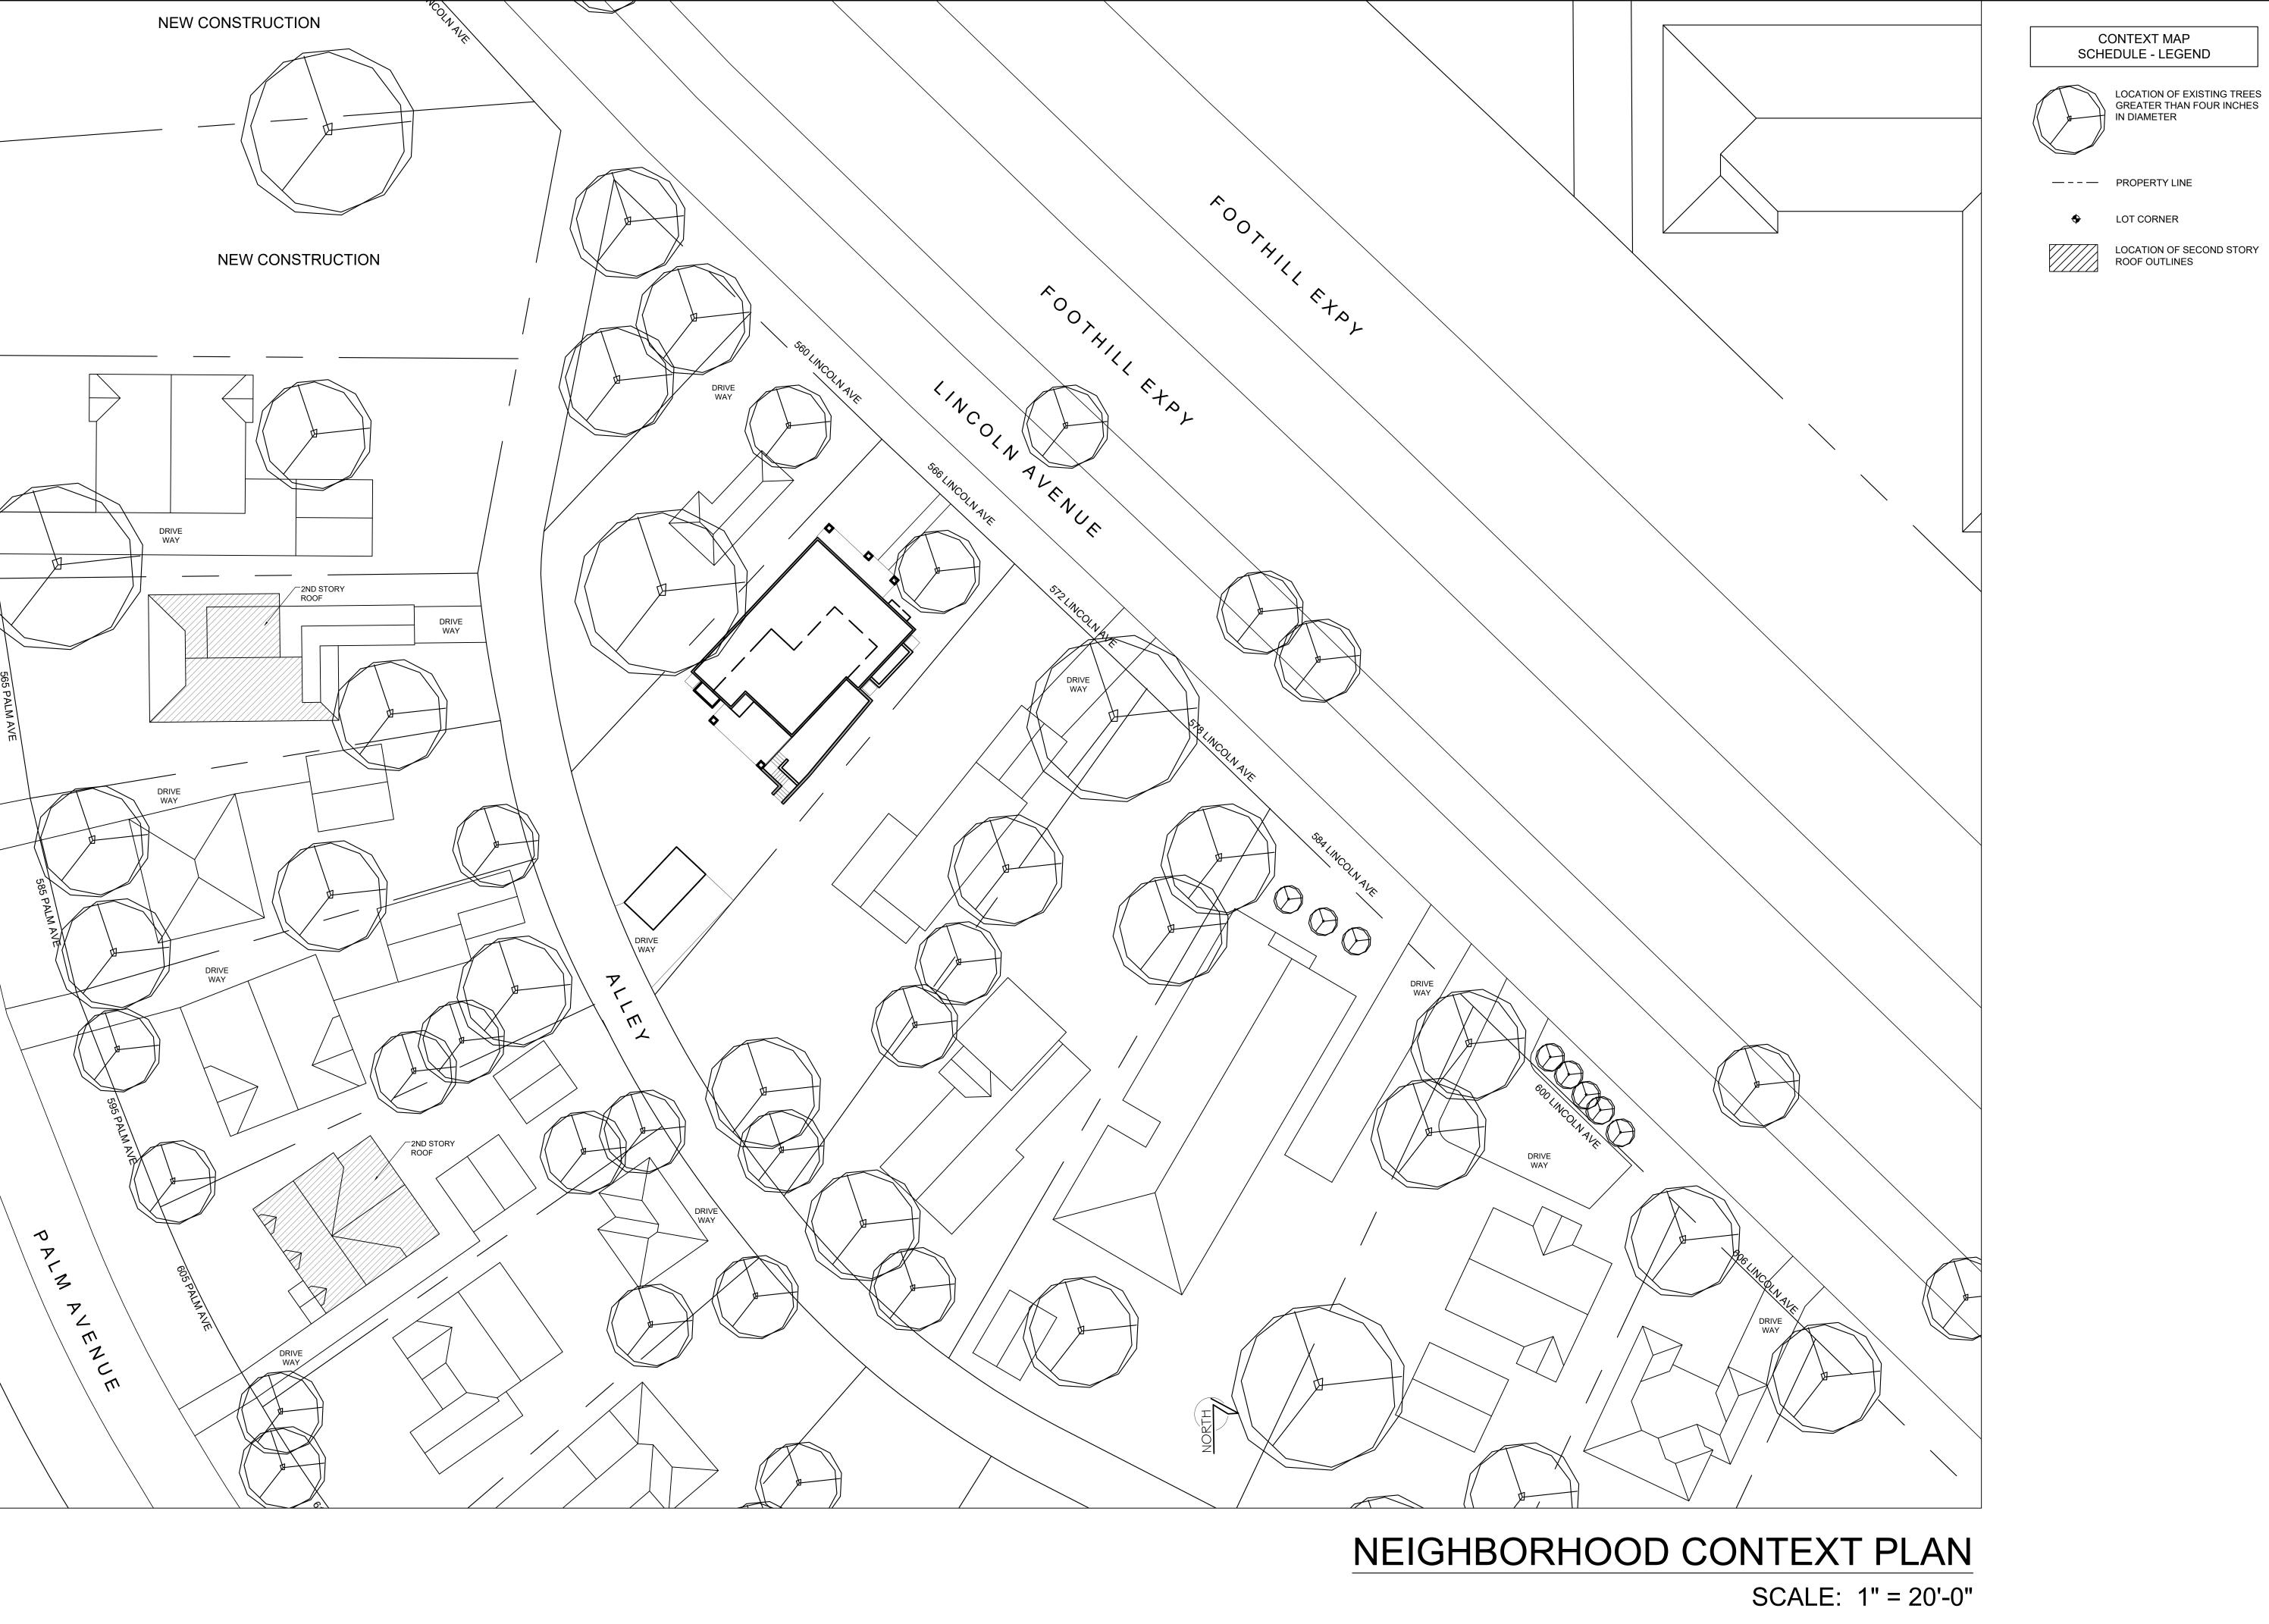G1.1

FLOOR AREA AND COVERAGE CALCULATIONS


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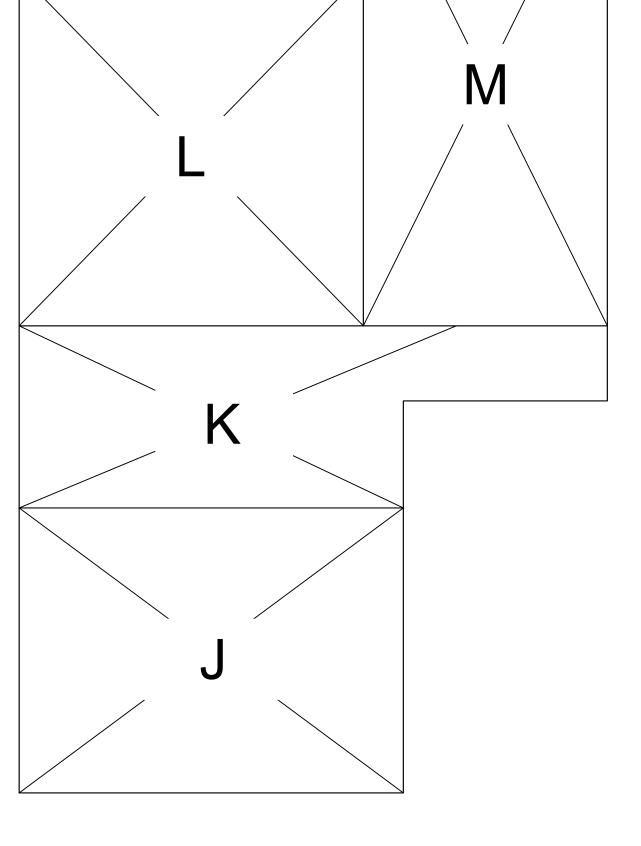
16'-6" x 23'-2'


<u>AREA</u>

379 SQ FT

SECTION



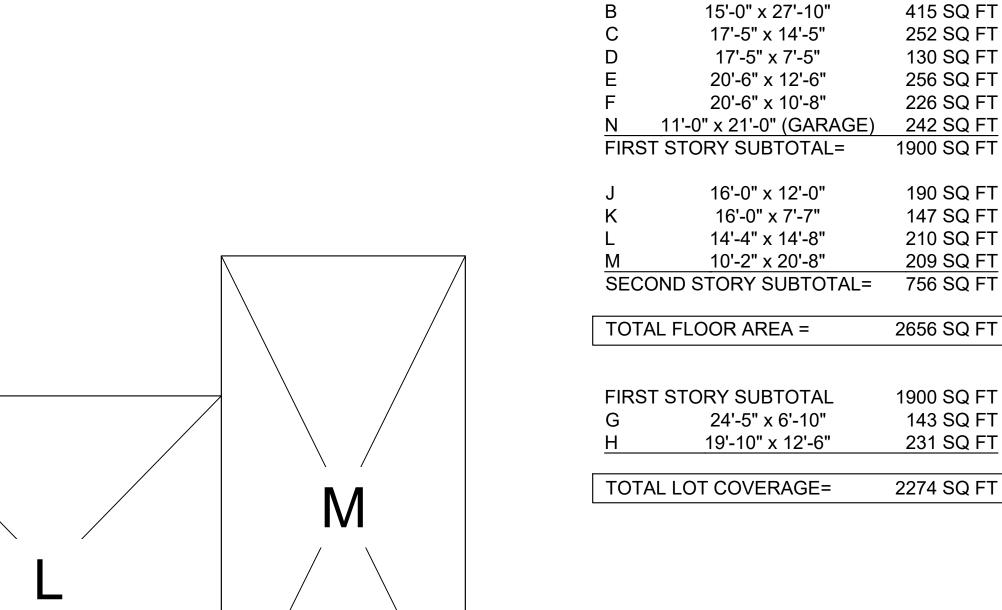

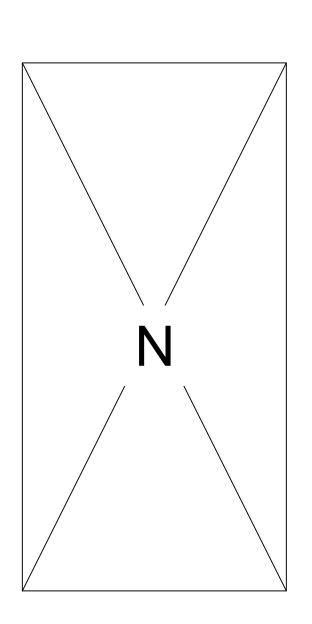

FIRST STORY

SECOND STORY


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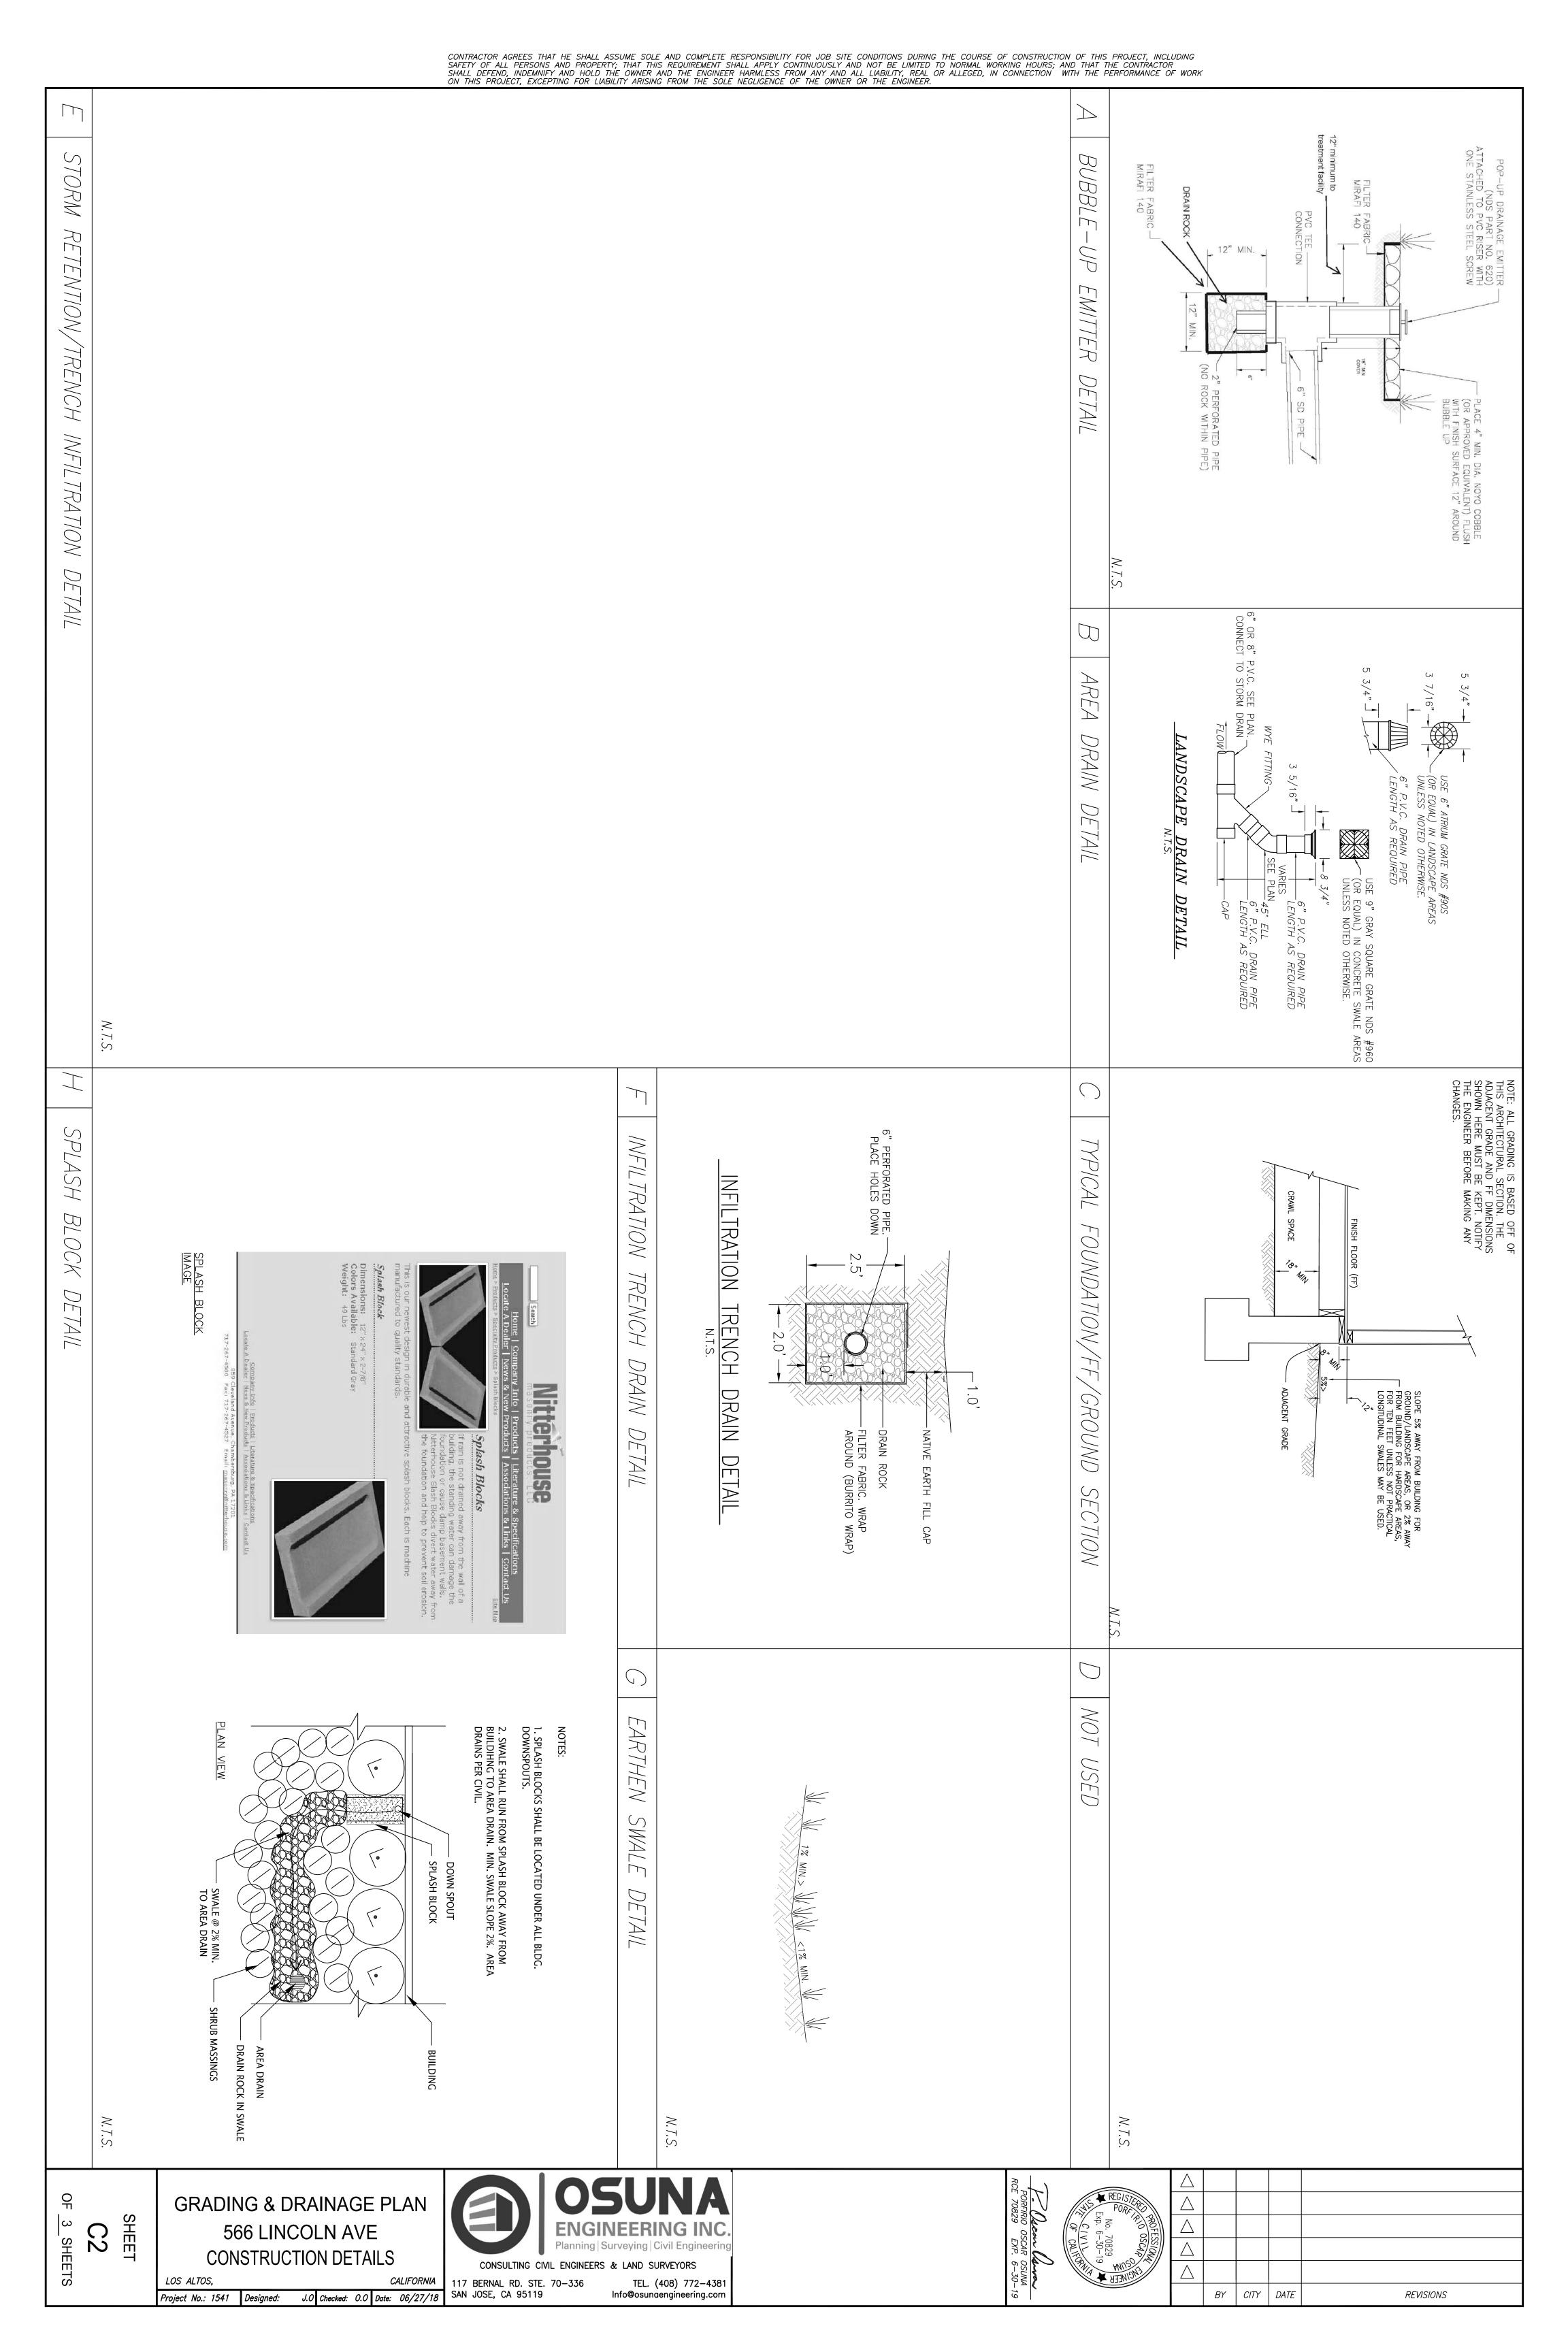
FLOOR AREA AND COVERAGE CALCULATION DIAGRAM


SCALE: 1/4" = 1"

BENINTENDI DESIGNER

G1.2



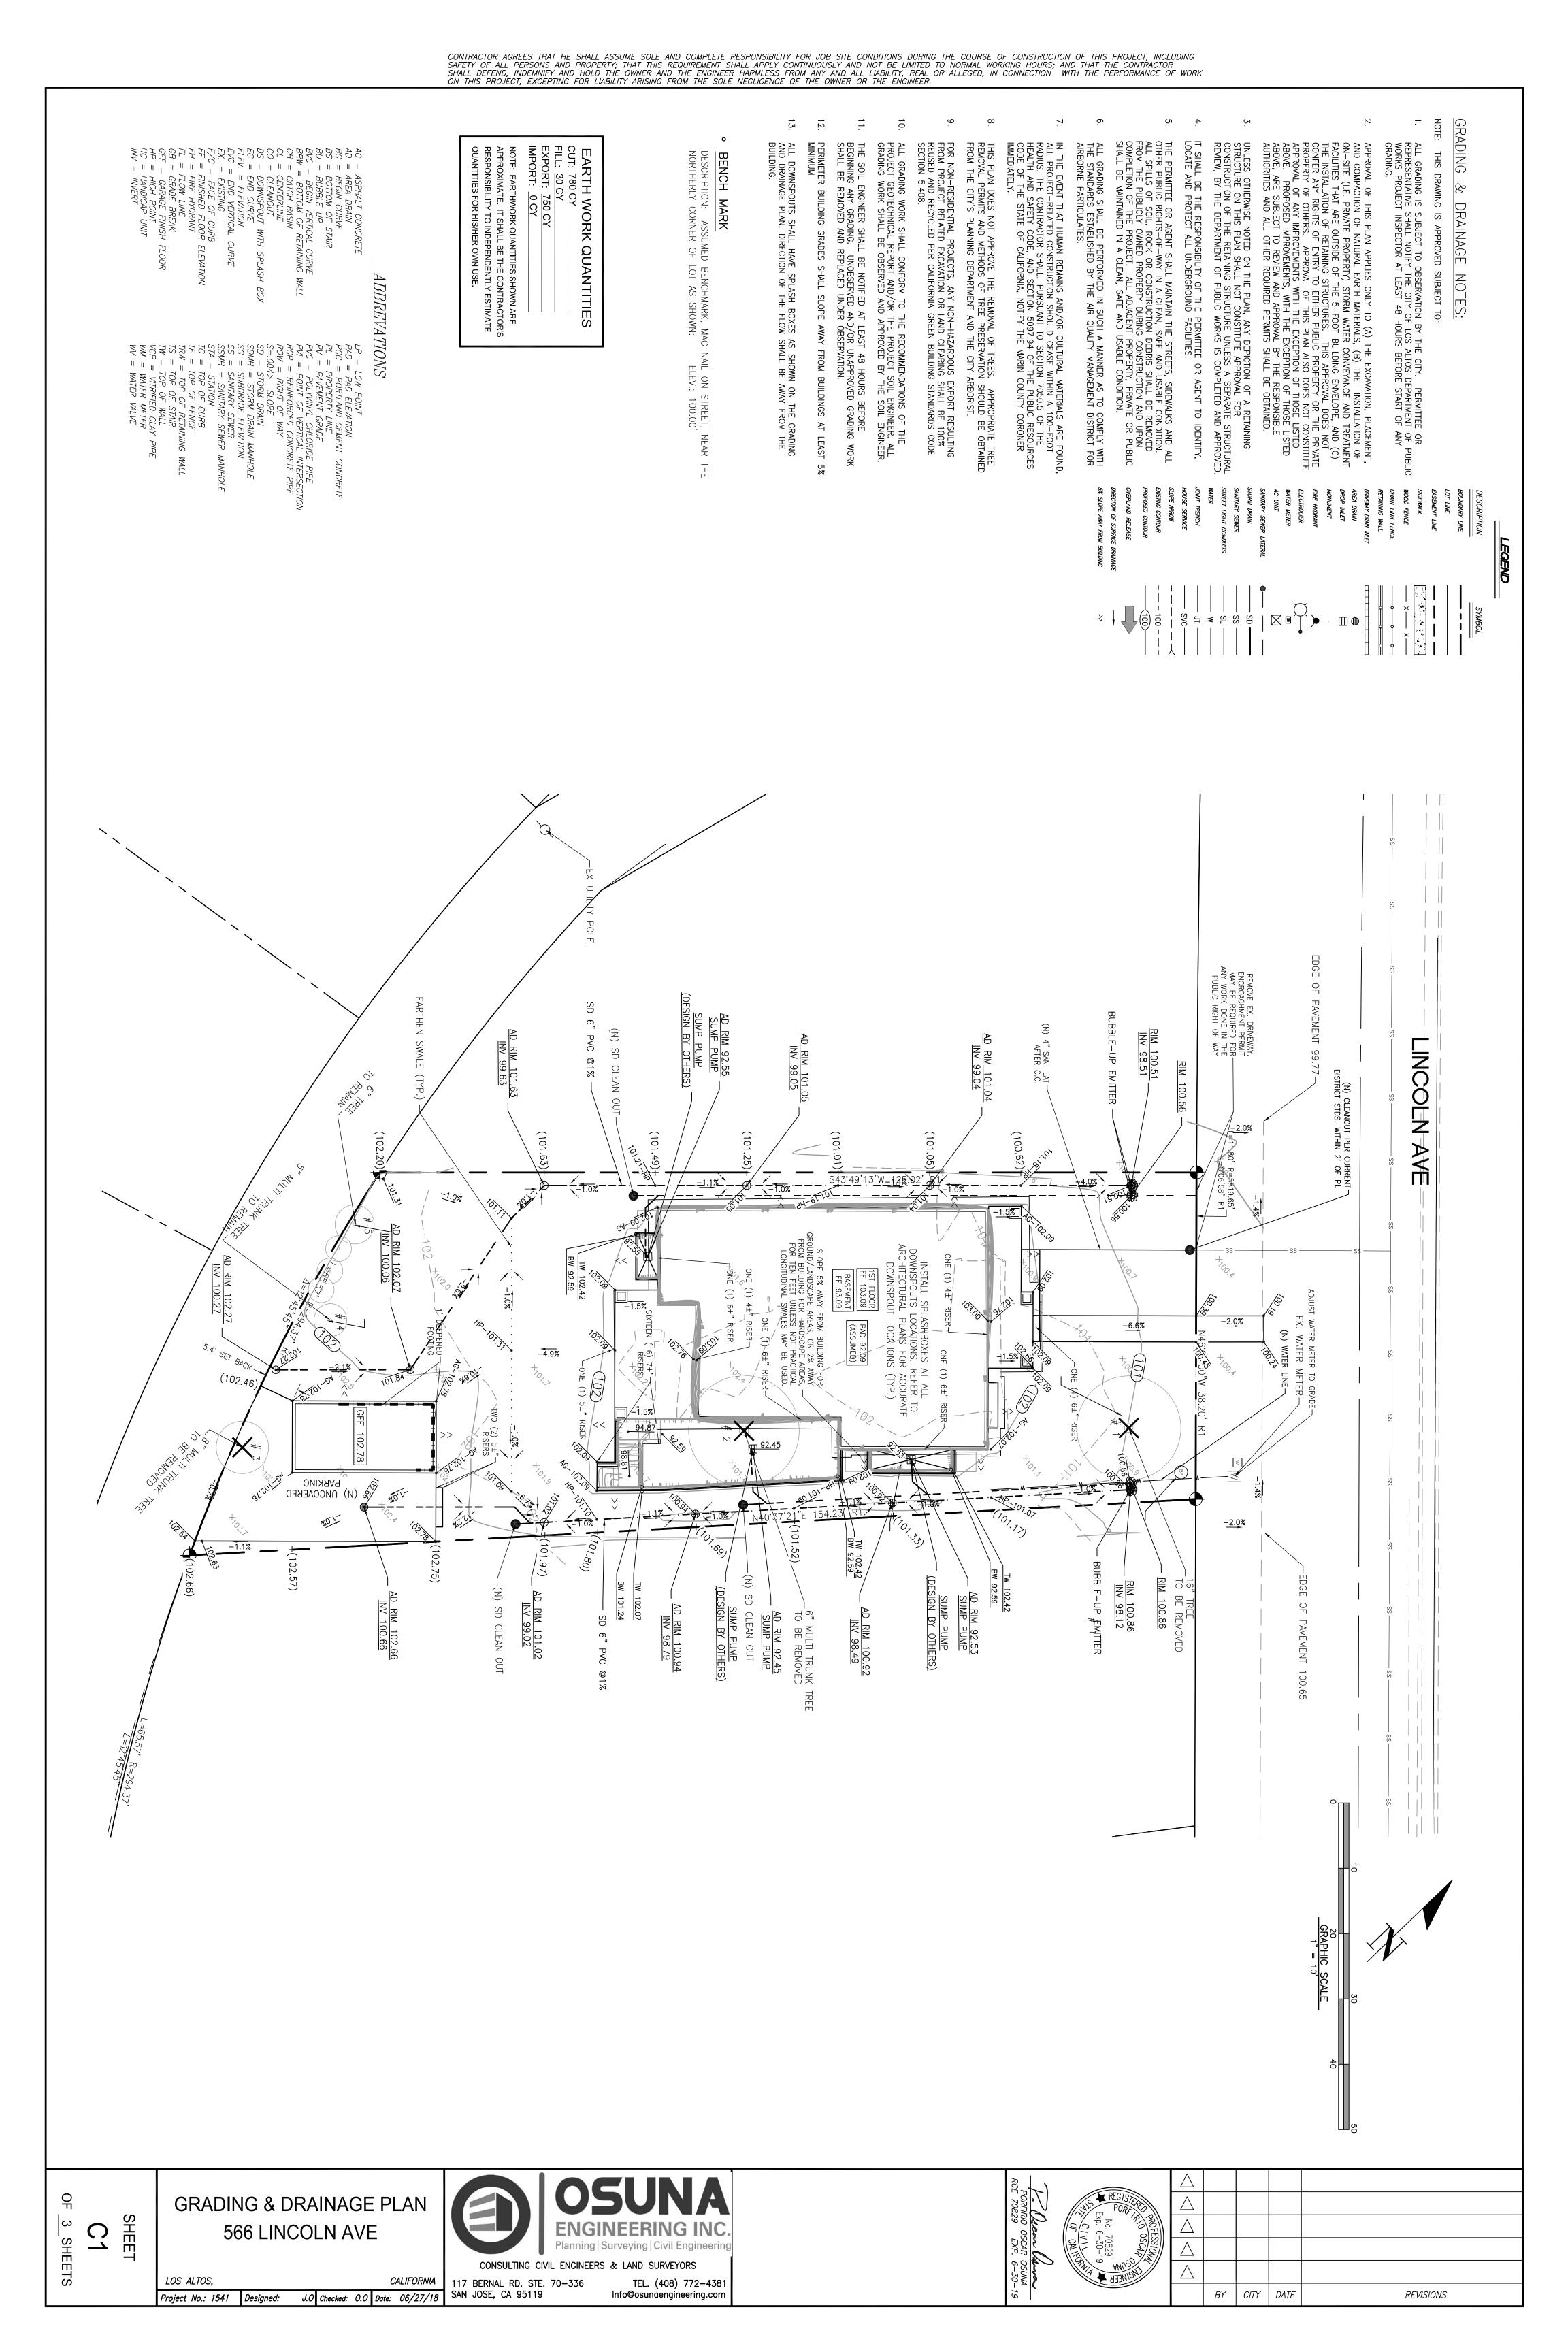

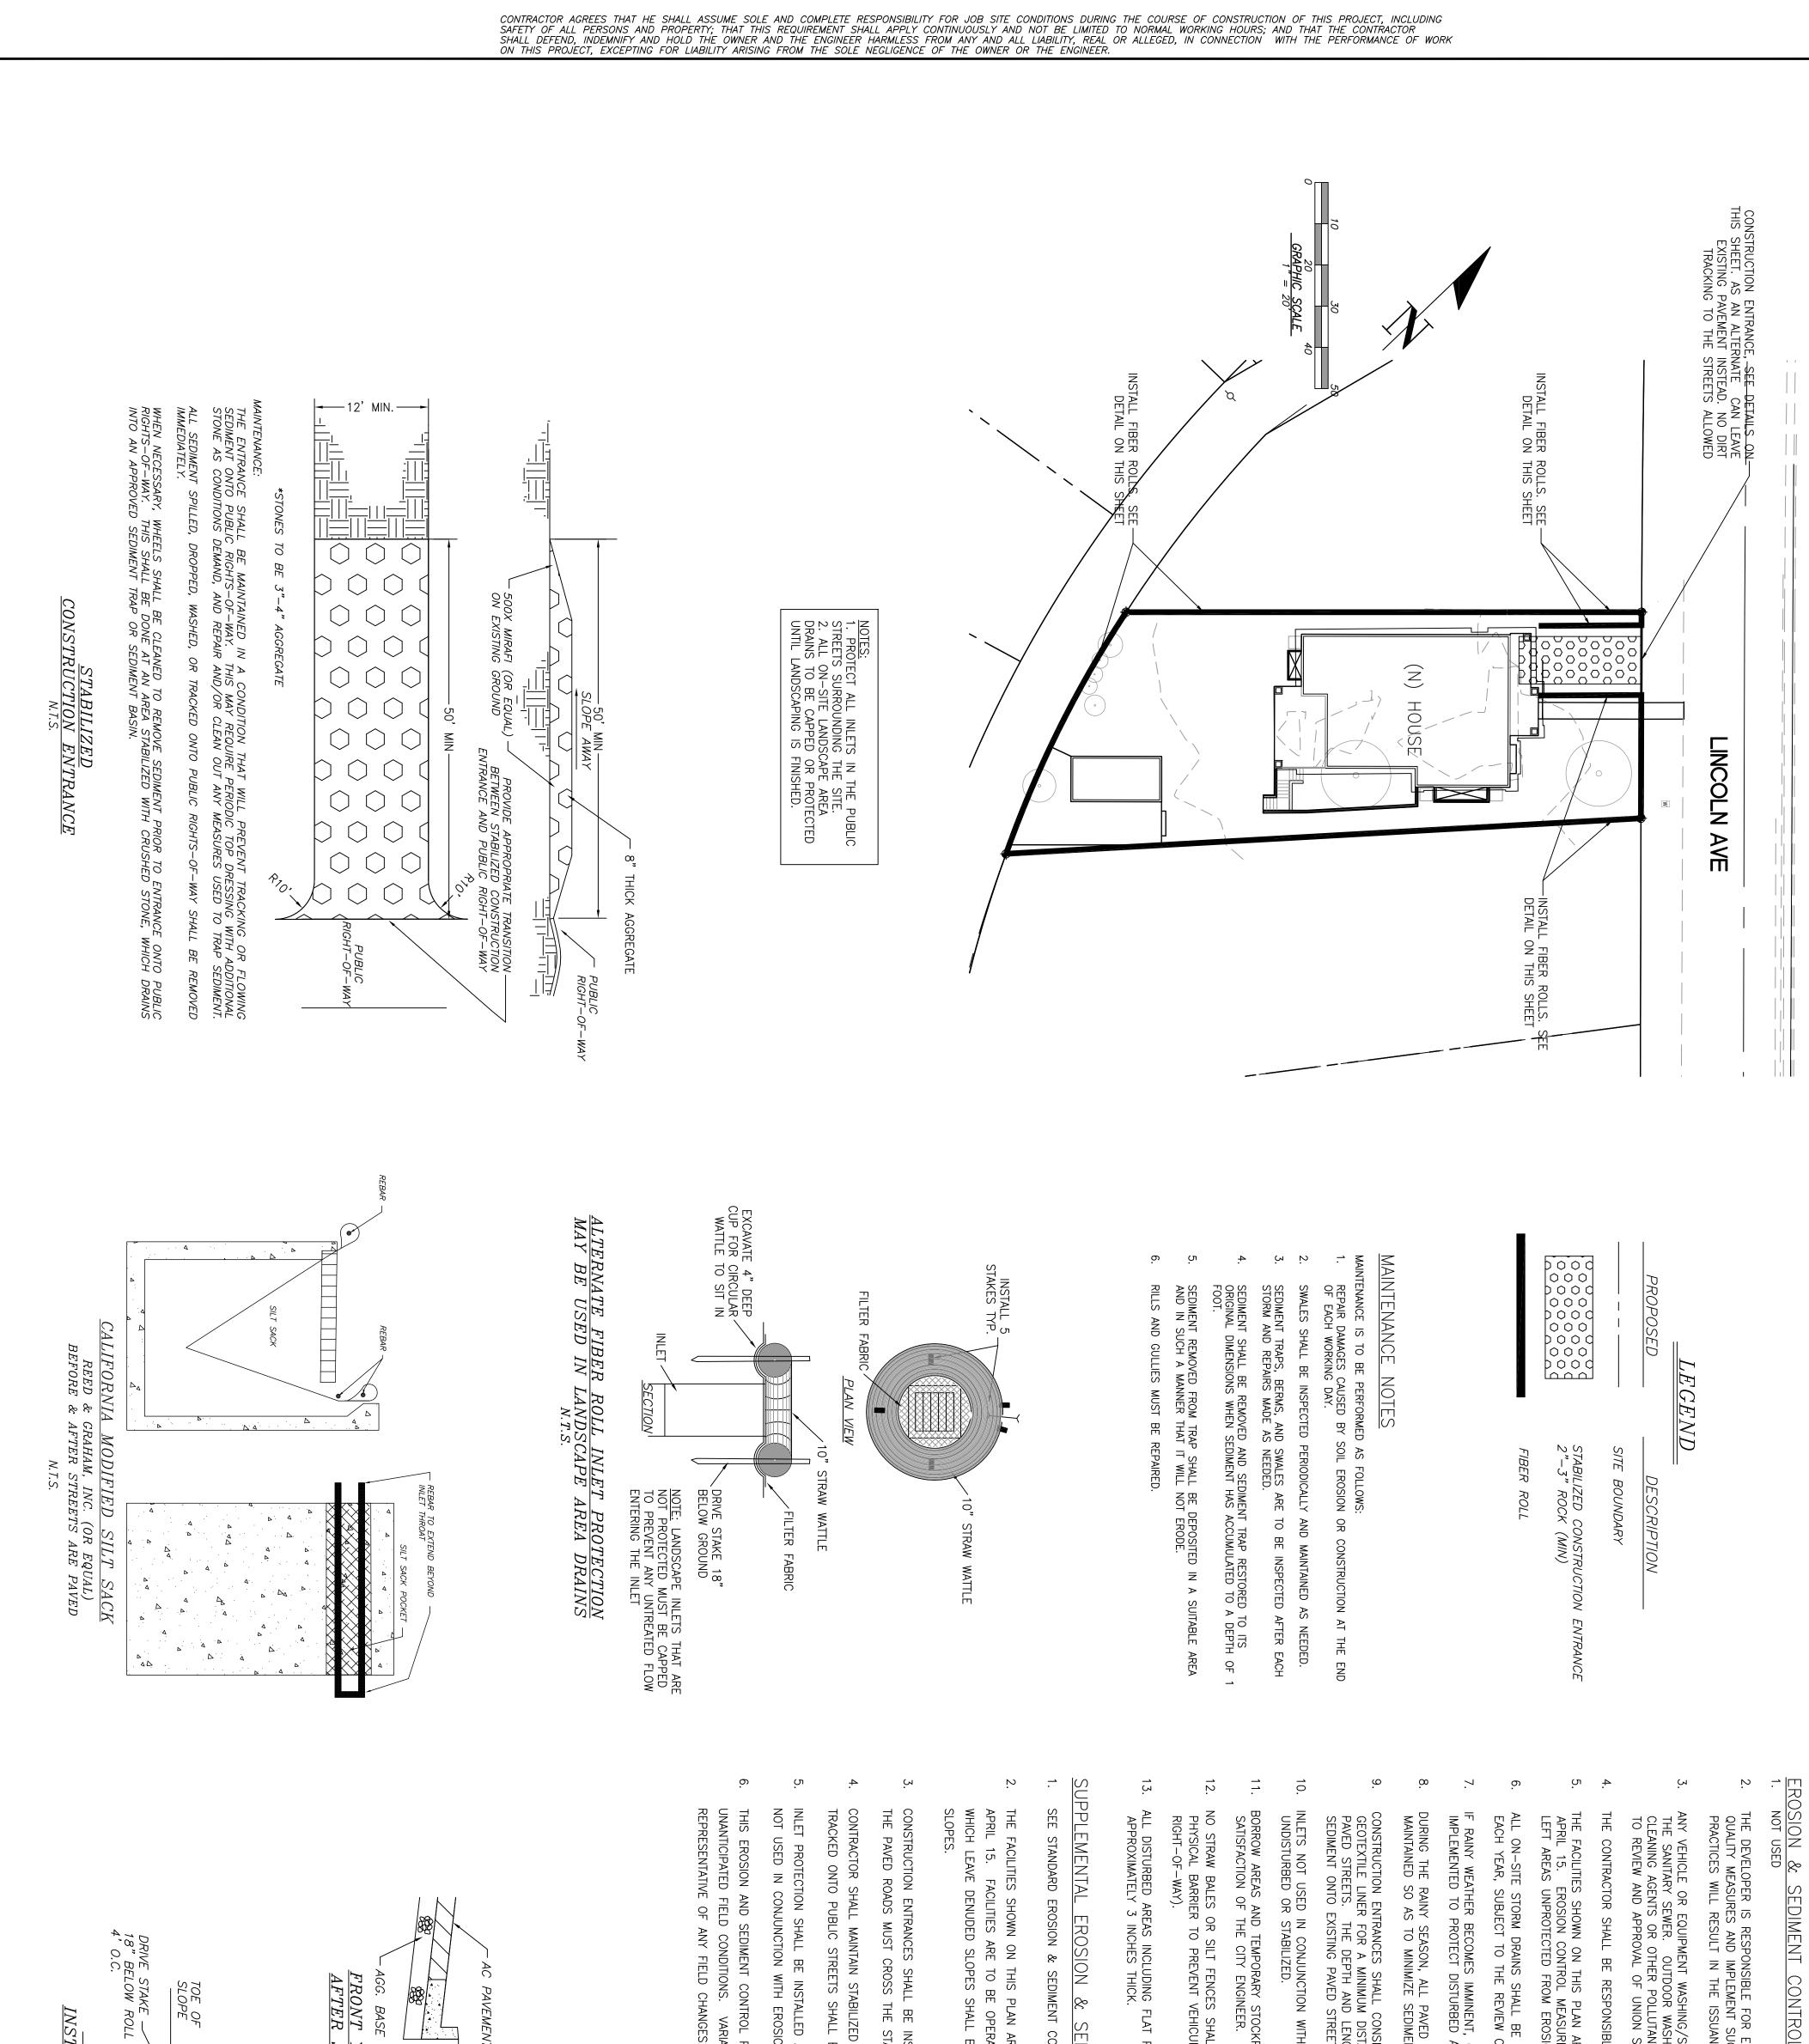

SEDIMENT CON TROL NOTES

THE DEVELOPER IS RESPONSIBLE FOR ENSURING THAT ALL CONTRACTORS AND SUBCONTRACTORS ARE AWARE OF ALL STORM WATER QUALITY MEASURES AND IMPLEMENT SUCH MEASURES. FAILURE TO COMPLY WITH THE APPROVED CONSTRUCTION BEST MANAGEMENT PRACTICES WILL RESULT IN THE ISSUANCE OF CORRECTION NOTICES, CITATIONS, AND/OR STOP ORDERS.

ANY VEHICLE OR EQUIPMENT WASHING/STEAM CLEANING MUST BE DONE AT AN APPROPRIATELY EQUIPPED FACILITY WHICH DRAINS TO THE SANITARY SEWER. OUTDOOR WASHING MUST BE MANAGED IN SUCH A WAY THAT THERE IS NO DISCHARGE OF SOAPS, SOLVENTS, CLEANING AGENTS OR OTHER POLLUTANTS TO THE STORM DRAINS. WASH WATER SHALL DISCHARGE TO THE SANITARY SEWER, SUBJECT TO REVIEW AND APPROVAL OF UNION SANITARY DISTRICT.

THE CONTRACTOR SHALL BE RESPONSIBLE FOR LITTER CONTROL AND SWEEPING OF ALL PAVED SURFACES DURING CONSTRUCTION AN ARE DESIGNED TO CONTROL EROSION AND SEDIMENT DURING THE RAINY SEASON, OCTOBER 1 TO ASURES ARE TO BE FUNCTIONAL PRIOR TO OCTOBER 1ST OF ANY YEAR GRADING OPERATIONS HAVE

ALL ON-SITE STORM DRAINS SHALL BE CLEANED IMMEDIATELY BEFORE THE START OF THE RAINY SEASON BEGINNING ON OCTOBER EACH YEAR, SUBJECT TO THE REVIEW OF THE BUILDING/ENGINEERING INSPECTOR. F RAINY WEATHER BECOMES IMMINENT, GRADING OPERATIONS SHALL BE STOPPED AND EROSION CONTROL MEASURES SHALL BE IMPLEMENTED TO PROTECT DISTURBED AREAS.

DURING THE RAINY SEASON, ALL PAVED AREAS SHALL BE MAINTAINED SO AS TO MINIMIZE SEDIMENT LADEN RUNOFF KEPT CLEAR OF EARTH MATERIAL AND DEBRIS. F TO ANY STORM DRAIN SYSTEM. 품 SITE SHALL

INLETS NOT USED IN CONJUNCTION WITH EROSION CONTROL MEASURES ARE TO BE BLOCKED UNLESS THE AREA DRAINED IS UNDISTURBED OR STABILIZED. CONSIST OF A MINIMUM 8" THICK LAYER OF 3"-4" FF M DISTANCE OF 50 FEET, AND IS TO BE PROVIDED AT D LENGTH OF AGGREGATE MAY NEED TO BE ADJUSTED STREETS. CONSTRUCTION ENTRANCES SHALL SLOPE AN " FRACTURED STONE AGGREGATE UNLAID WITH AT EACH VEHICLE ACCESS POINT TO EXISTING IN THE FIELD TO ENSURE NO TRACKING OF AWAY FROM EXISTING PAVED STREETS.

BORROW AREAS AND TEMPORARY STOCKPILES SATISFACTION OF THE CITY ENGINEER. SHALL ВE PROTECTED WITH APPROPRIATE EROSION CONTORL 0 0

NO STRAW BALES OR SILT FENCES SHALL BE USED AS EROSION CONTROL MEASURES. SILT FENCES MAY ONLY BE PHYSICAL BARRIER TO PREVENT VEHICULAR AND PEDESTRIAN TRAFFIC FROM USING NON—APPROVED ACCESS POINTS RIGHT—OF—WAY). USED AS (E.G. – / ALONG

FLAT PADS ARE TO BE TREATED WITH STRAW AND TACKIFIER AT A RATE OF TONS PER ACRE

EROSION & SEDIMENT CONTROL NOTES


SEE STANDARD EROSION & SEDIMENT CONTROL NOTES ABOVE.

THE FACILITIES SHOWN ON THIS PLAPRIL 15. FACILITIES ARE TO BE WHICH LEAVE DENUDED SLOPES SHALL BE PROTECTED WITH EROSION CONTROL MEASURES IMMEDIATELY FOLLOWING DESIGNED TO T0 OCTOBER 1 OF ANY YEAR. GRADING OPERATION OPERATIONS SEASON, GRADING RAINY OCTOBER 1 TO ON THE

CONSTRUCTION ENTRANCES SHALL
THE PAVED ROADS MUST CROSS TO BE INSTALLED PRIOR TO COMMENCEMENT OF GHE STABILIZED CONSTRUCTION ENTRANCE WAYS. OF GRADING. ALL CONSTRUCTION TRAFFIC ENTERING ONTO

CONTRACTOR SHALL MAINTAIN STABILIZED ENTRANCE TRACKED ONTO PUBLIC STREETS SHALL REMOVED AT EACH VEHICLE DAILY REQUIRED BY THE POINT TO CITY. EXISTING PAVED STREETS. ANY MUD OR DEBRIS

NOT USED IN CONJUNCTION WITH THIS EROSION AND SEDIMENT CONTROL PLAN MAY NOT COVER ALL THE SITUATIONS THAT MAY ARISE INLET PROTECTION SHALL BE INSTALLED AT VARIATIONS AND ADDITIONS MAY BE MADE TO THIS PLAN IN THE FIELD. TO TO BE PREVENT SEDIMENT FROM ENTERING BLOCKED TO PREVENT ENTRY DURING CONSTRUCTION DUE TO STORM DRAIN NOTIFY THE CITY

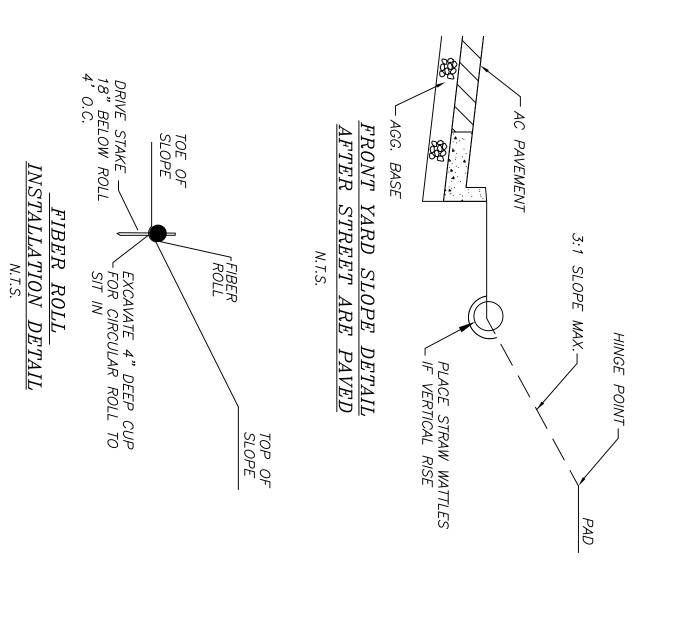

GRADING & DRAINAGE PLAN SHEET 566 LINCOLN AVE C3**EROSION CONTROL**

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SHEETS




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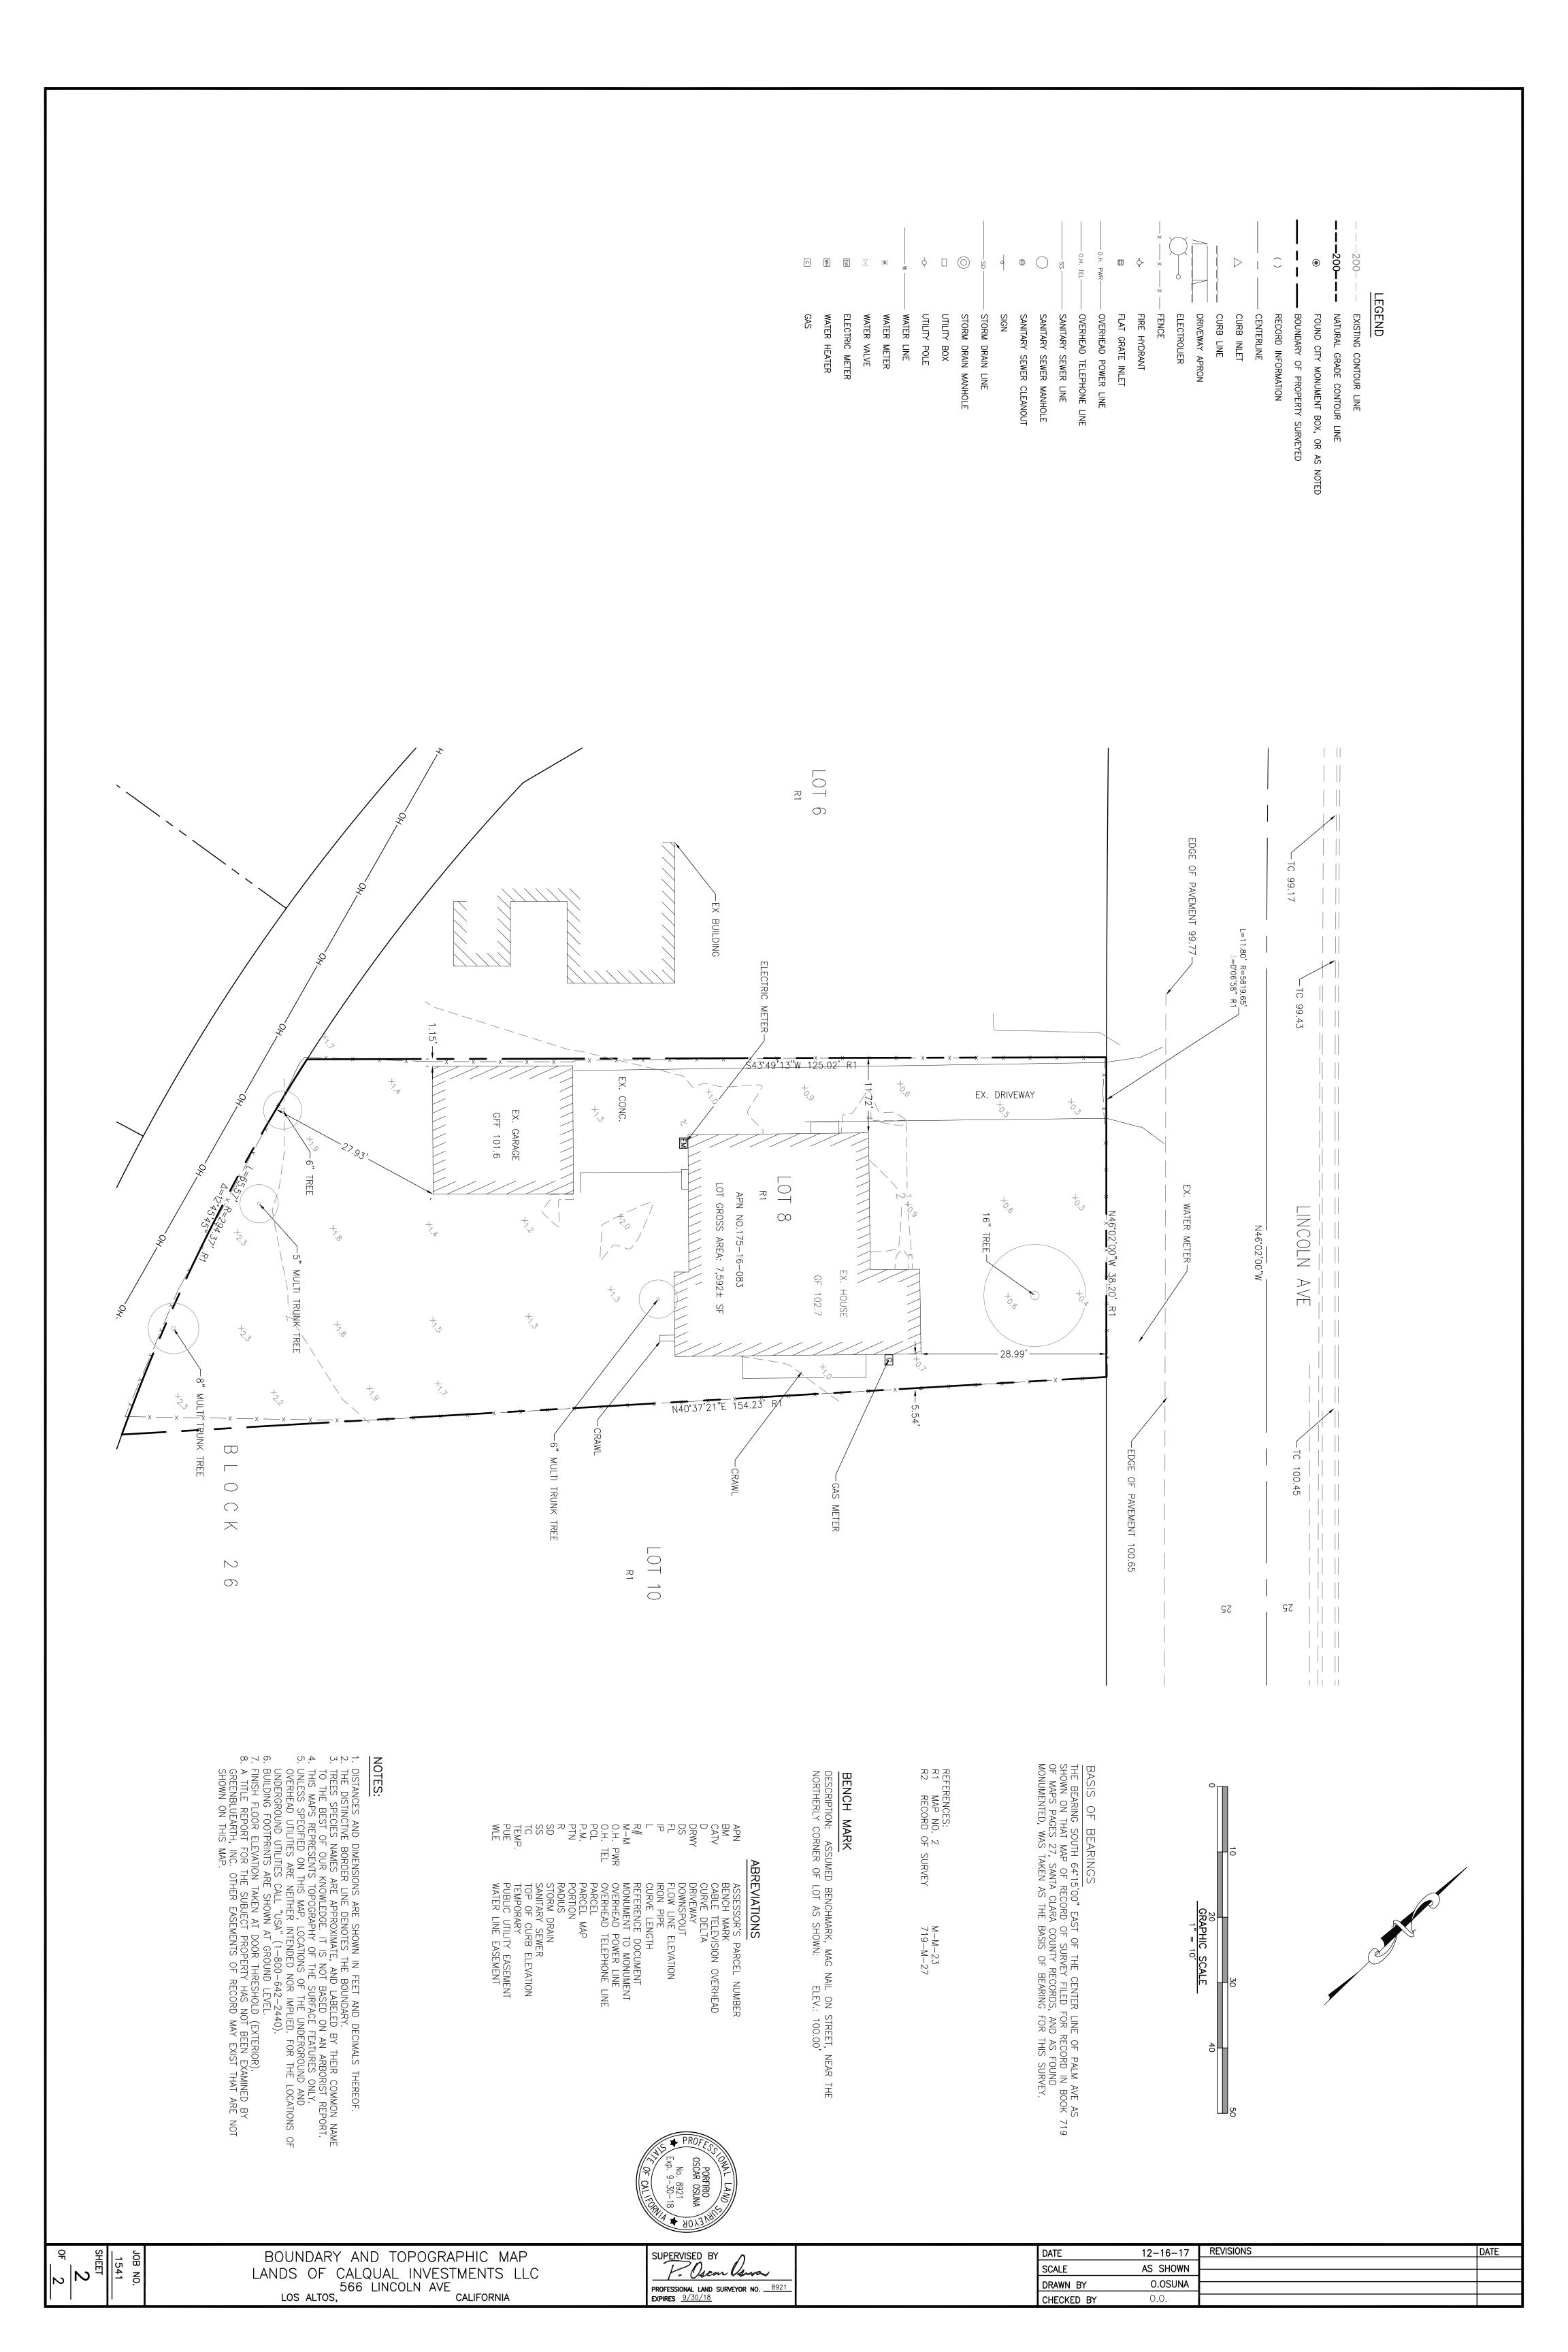
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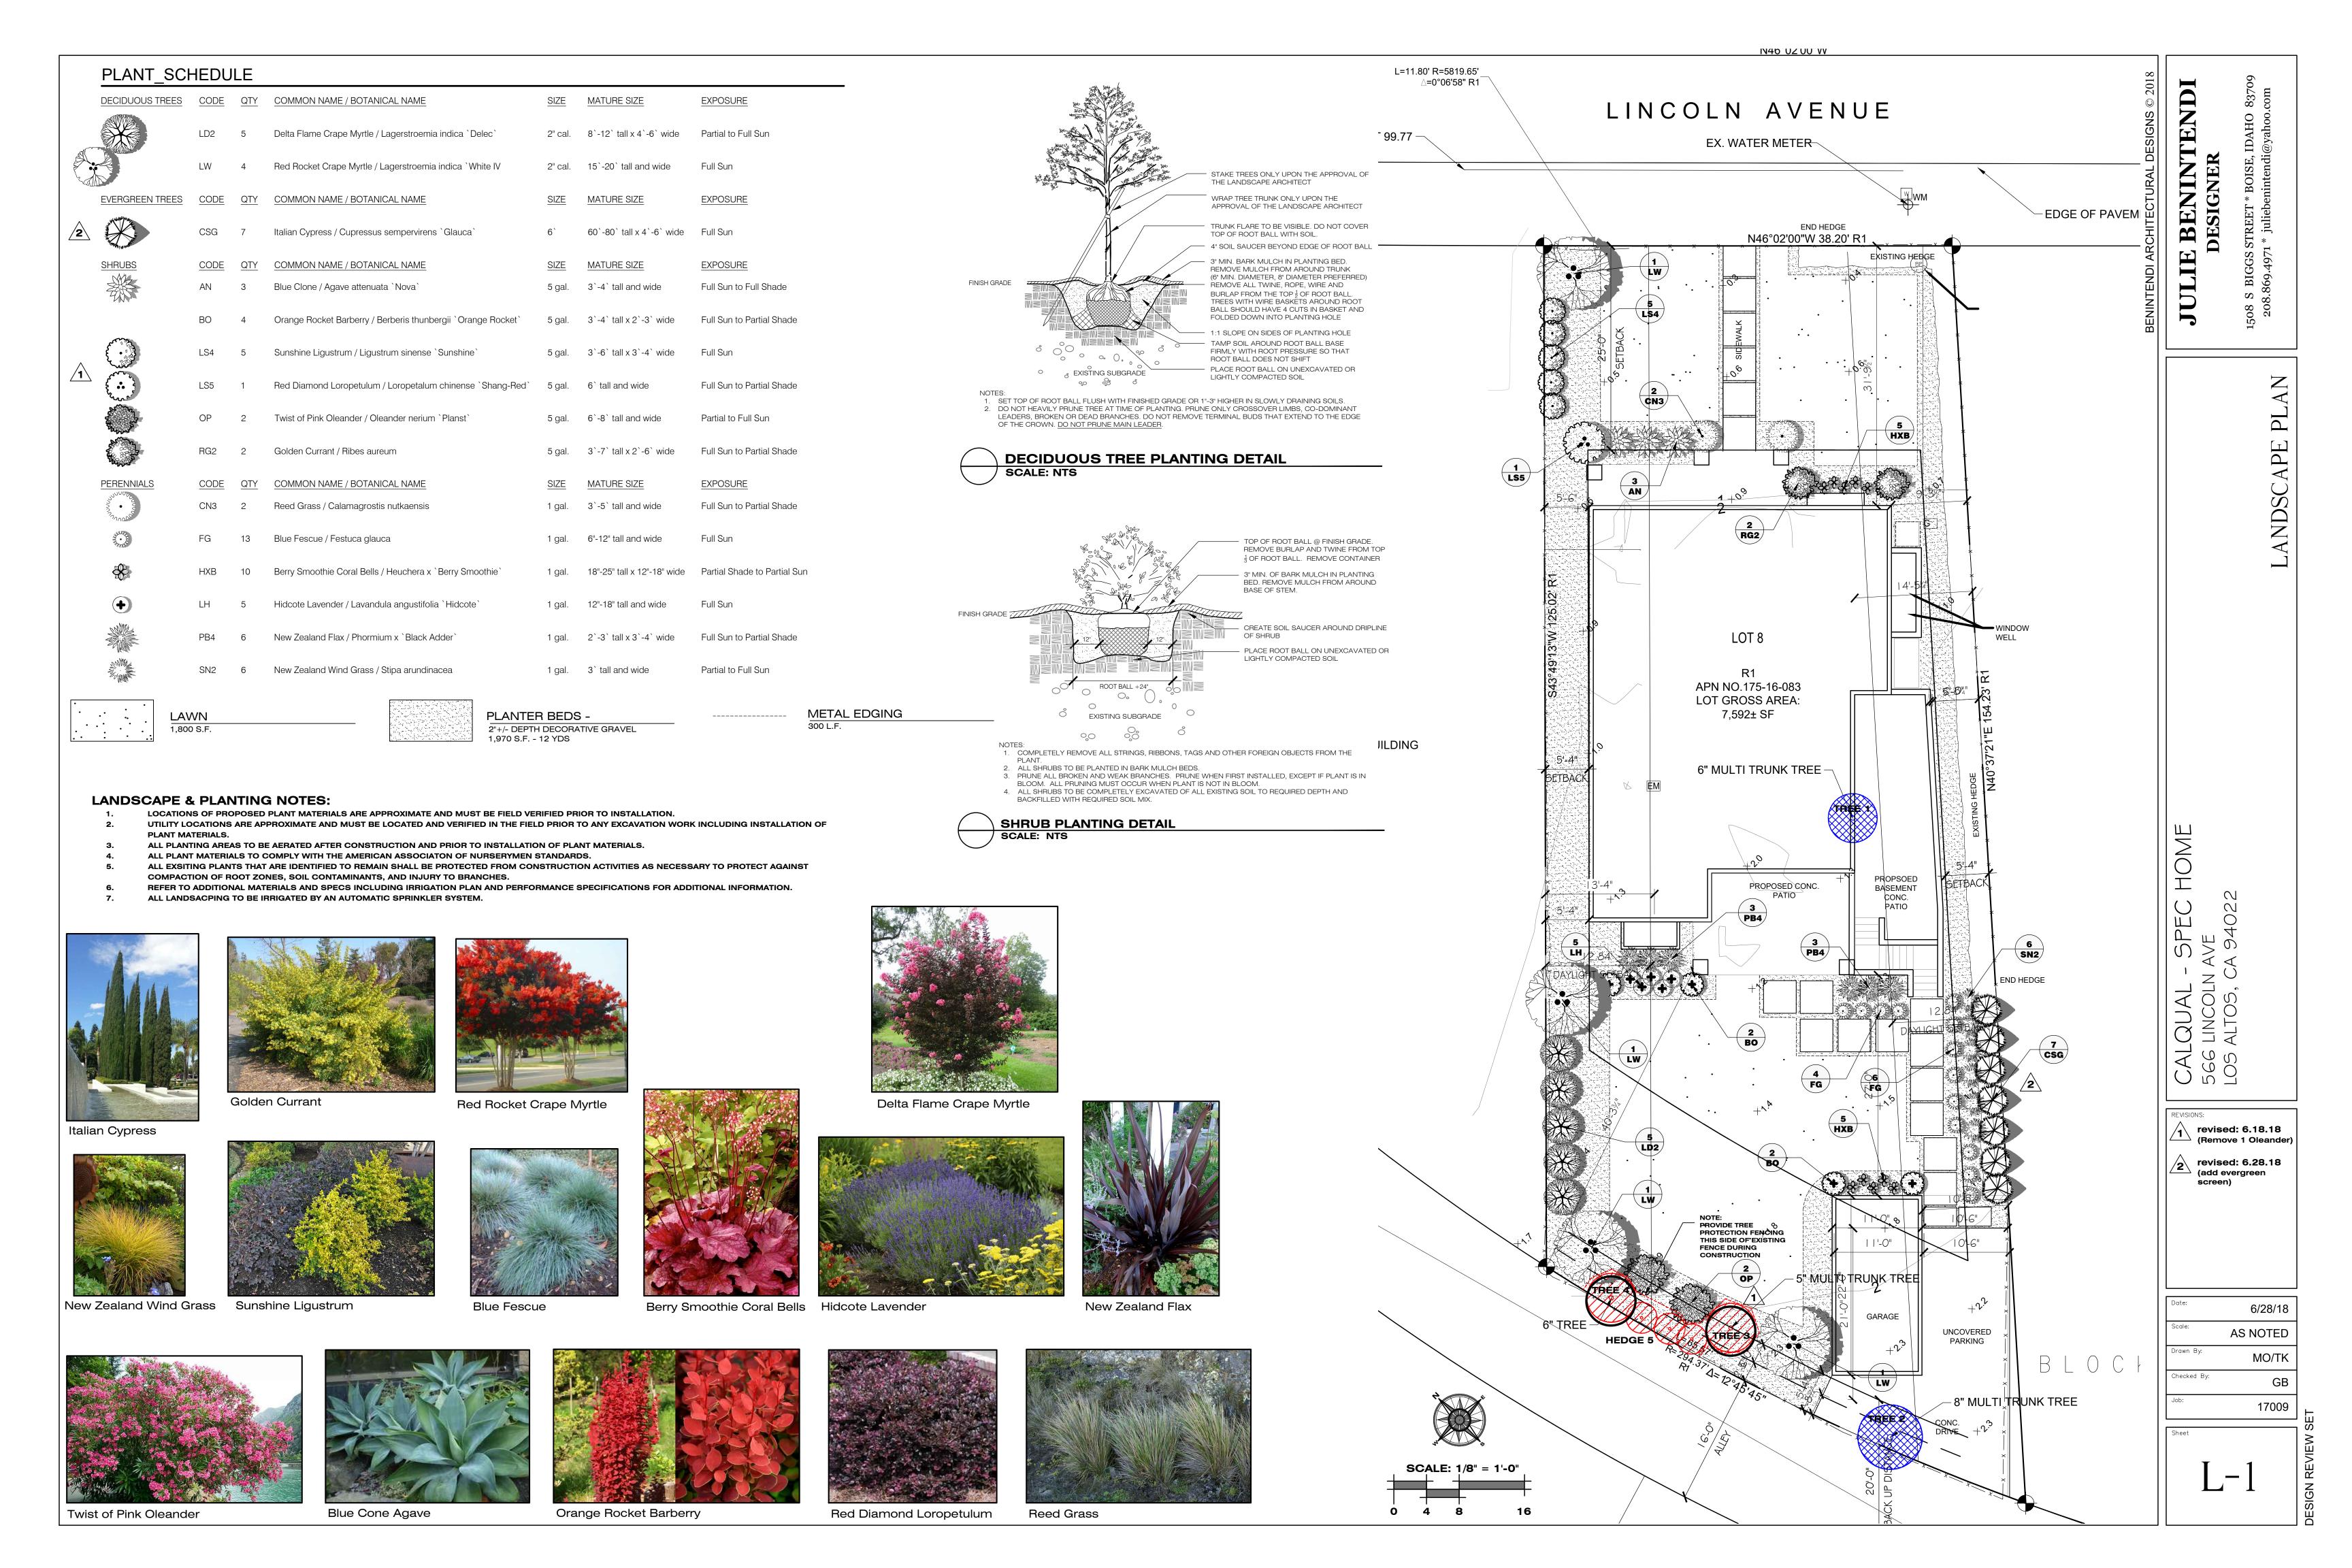
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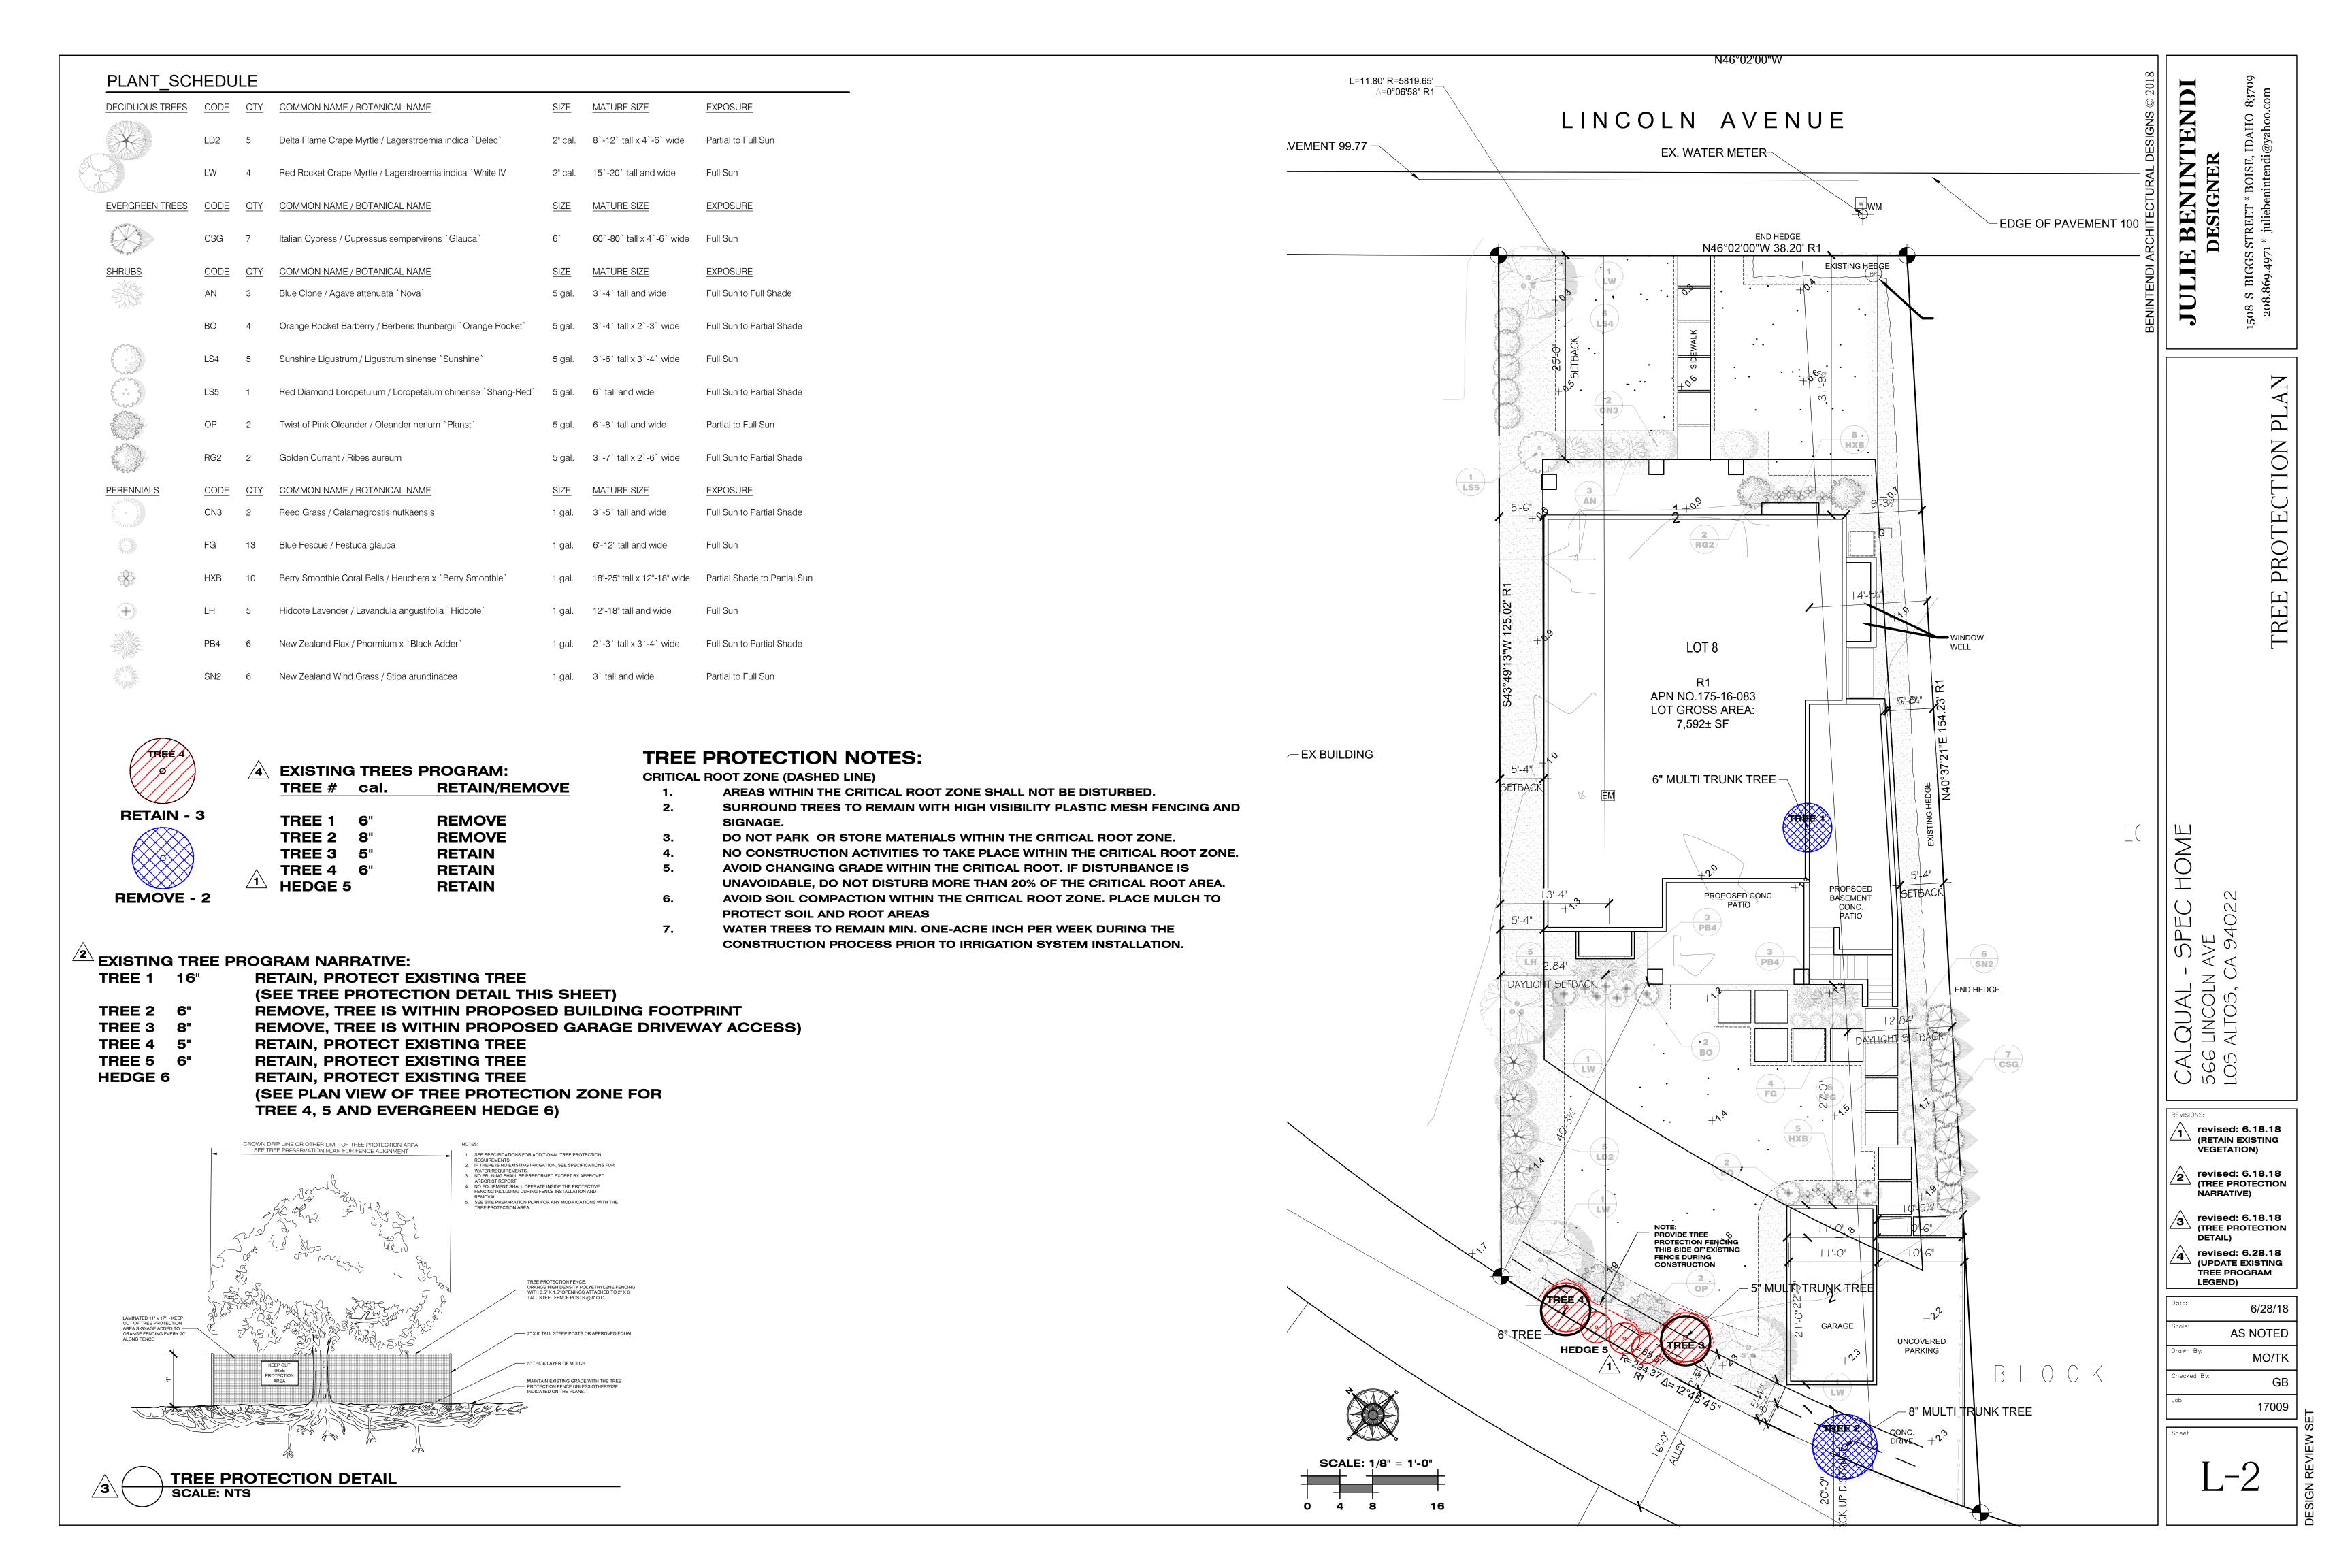
117 BERNAL RD. STE. 70-336 SAN JOSE, CA 95119


TEL. (408) 772-4381 Info@osunaengineering.com







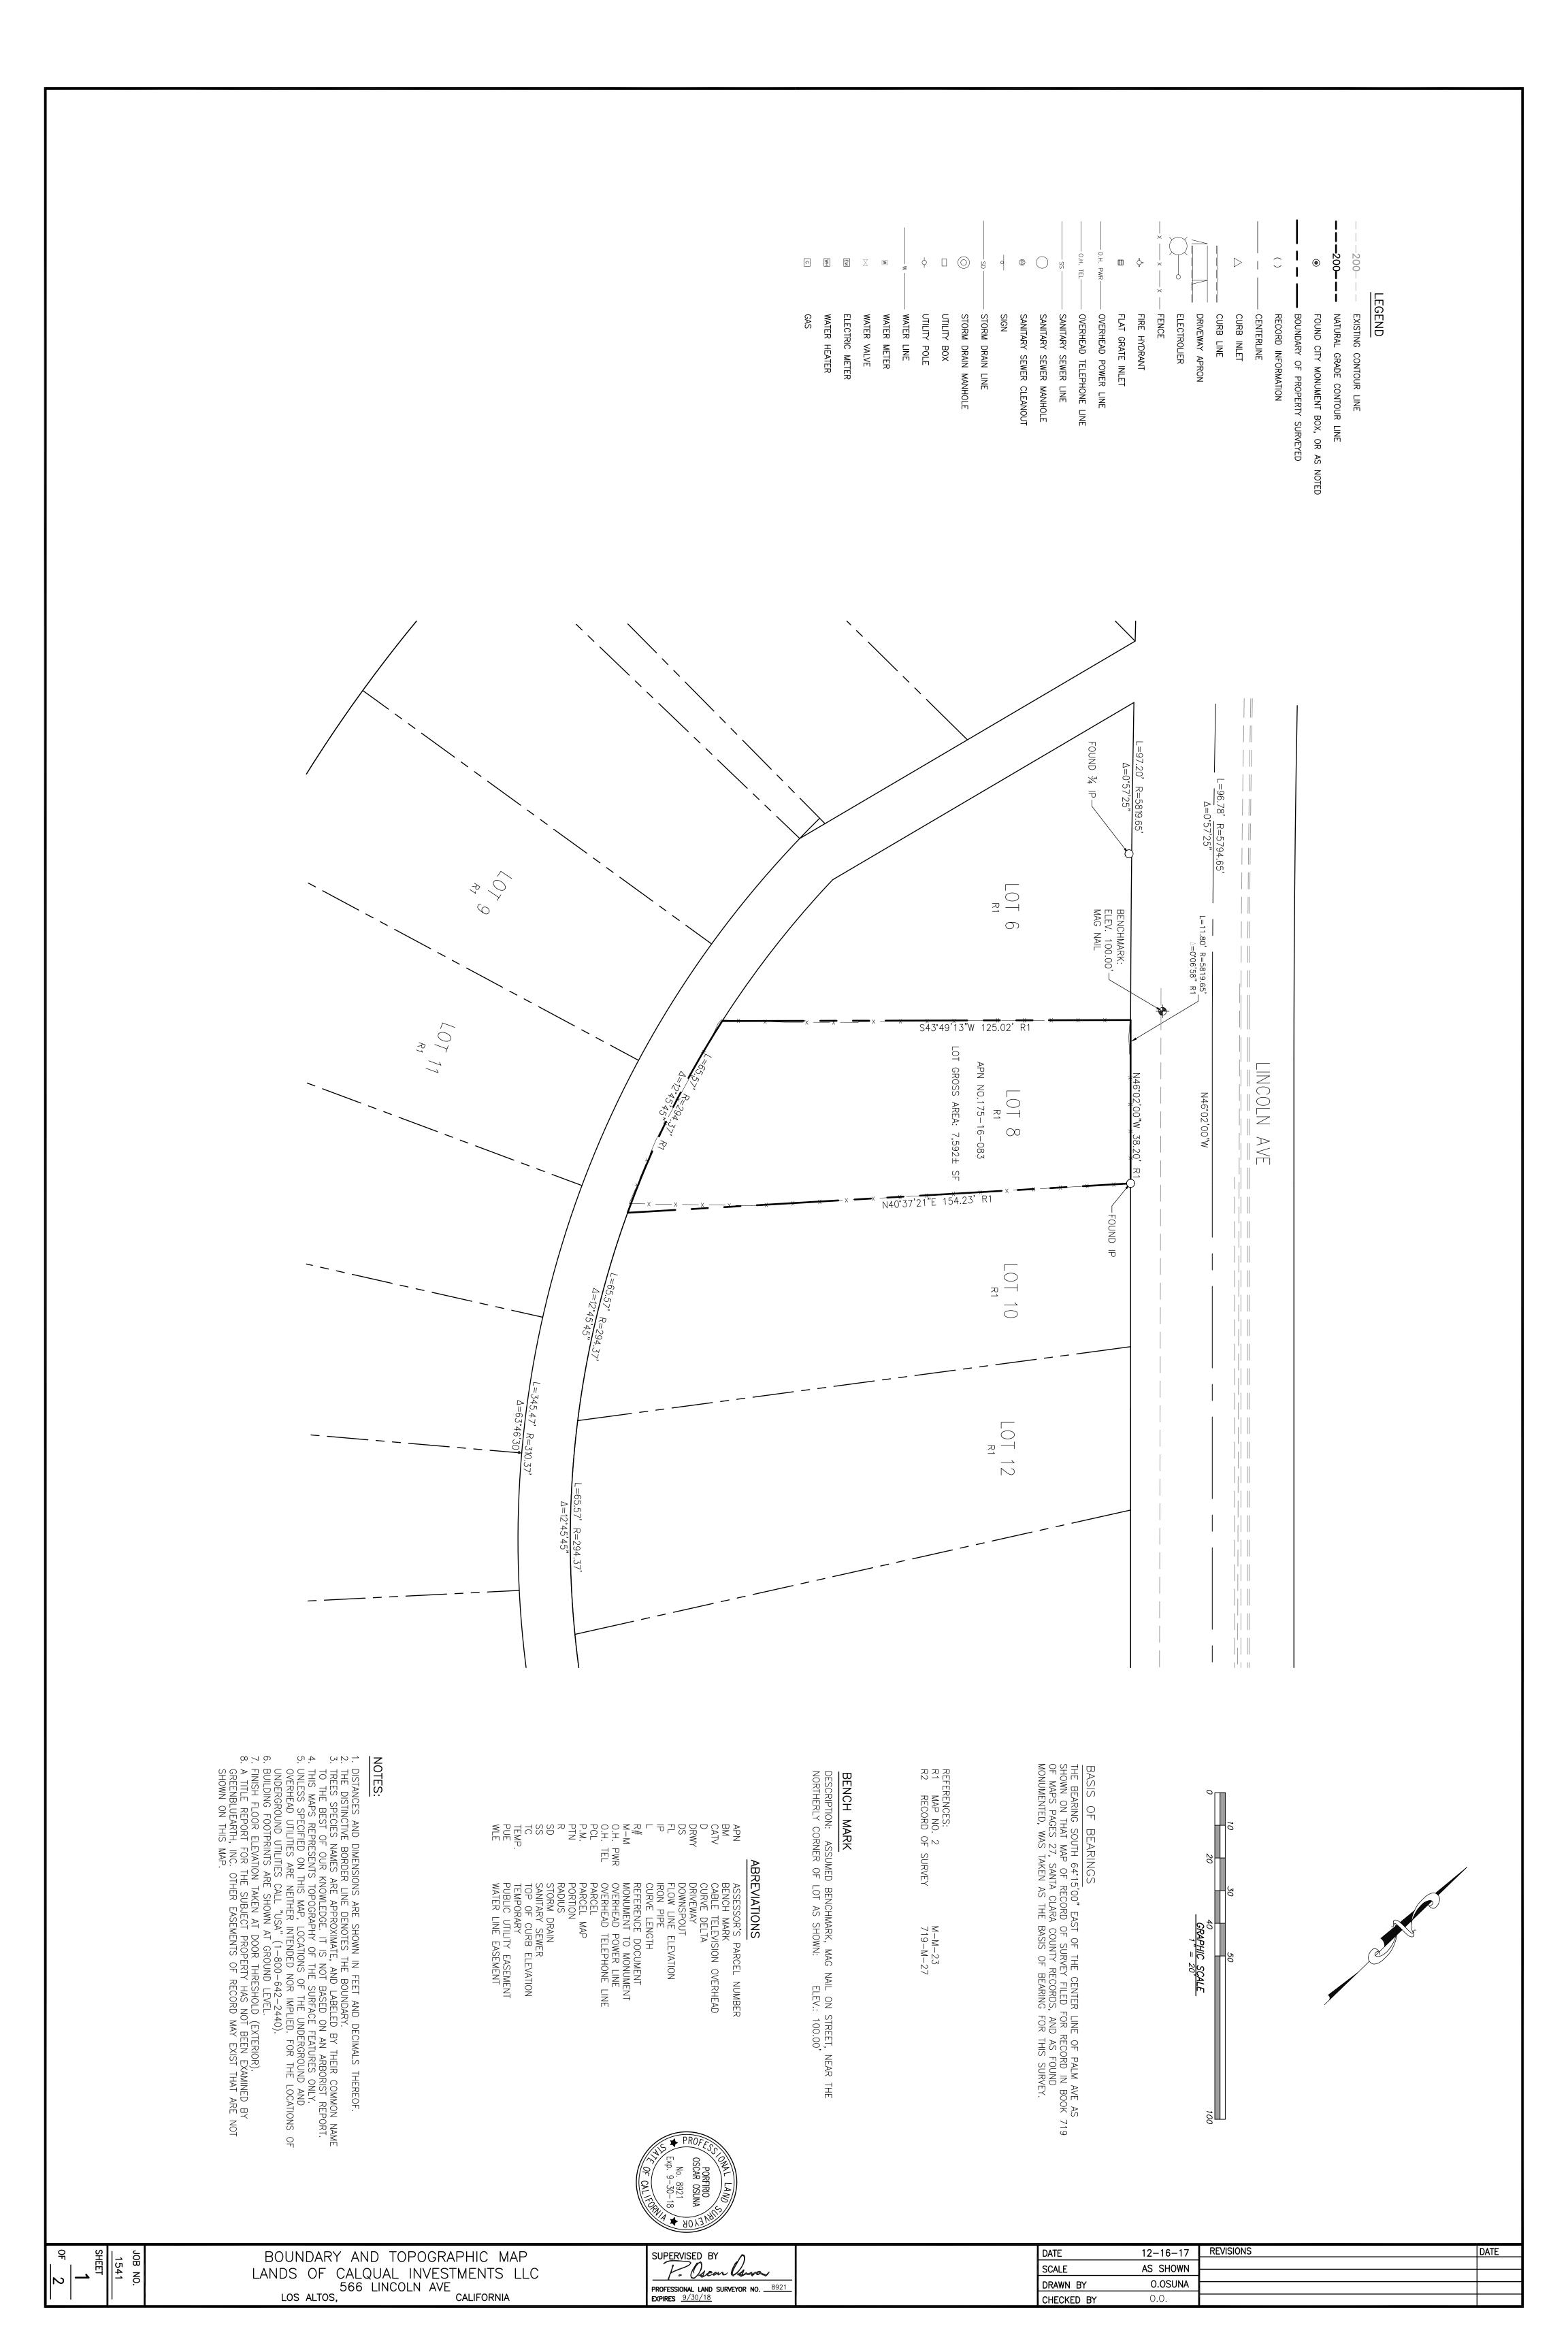

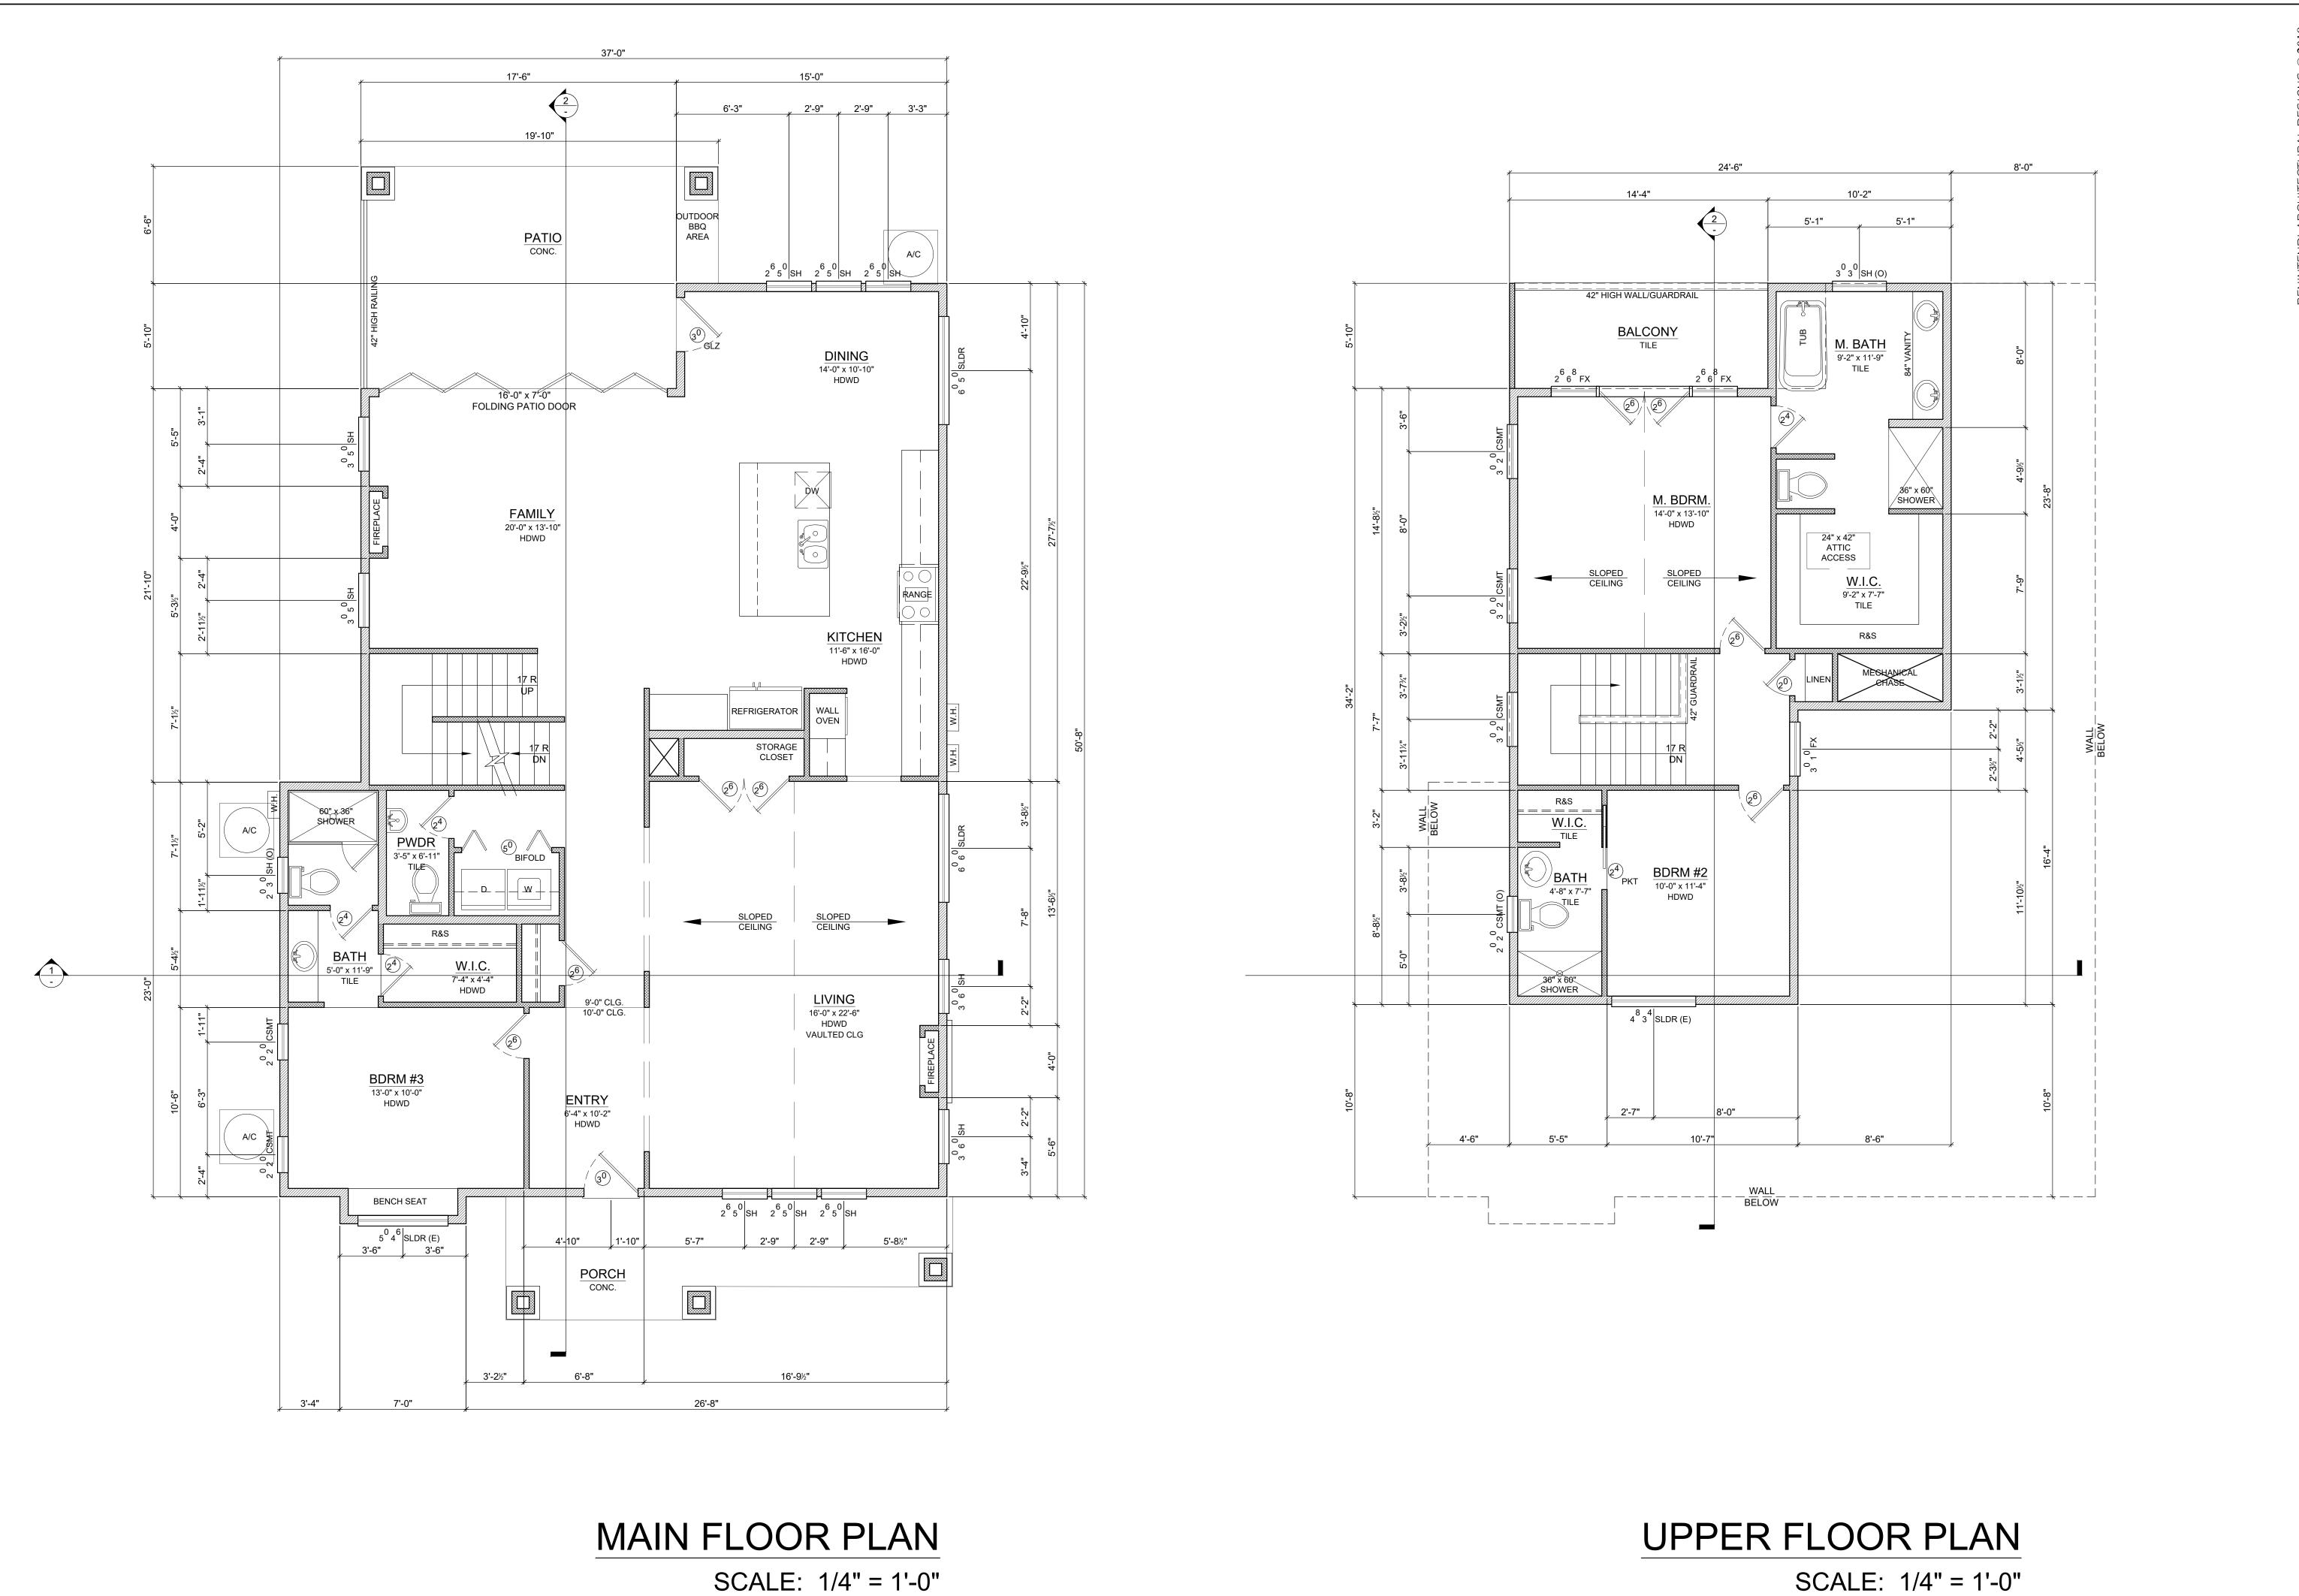

JULIE BENINTENDI

DESIGNER

8 UPPER FLOOR PLANS


ALQUAL - SPEC H 56 lincoln ave 05 altos, ca 94022

REVISIONS:

Date: 7/1/18
Scale: AS NOTED
Drawn By: JE

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5/12 SLOPE 5/12 SLOPE ROOF GUTTERS -- ROOF CRICKET 5/12 SLOPE FRAMED CHIMNEY WITH — STONE VENEER 5/12 SLOPE 5/12 SLOPE 5/12

FOUNDATION/BASEMENT FLOOR PLAN

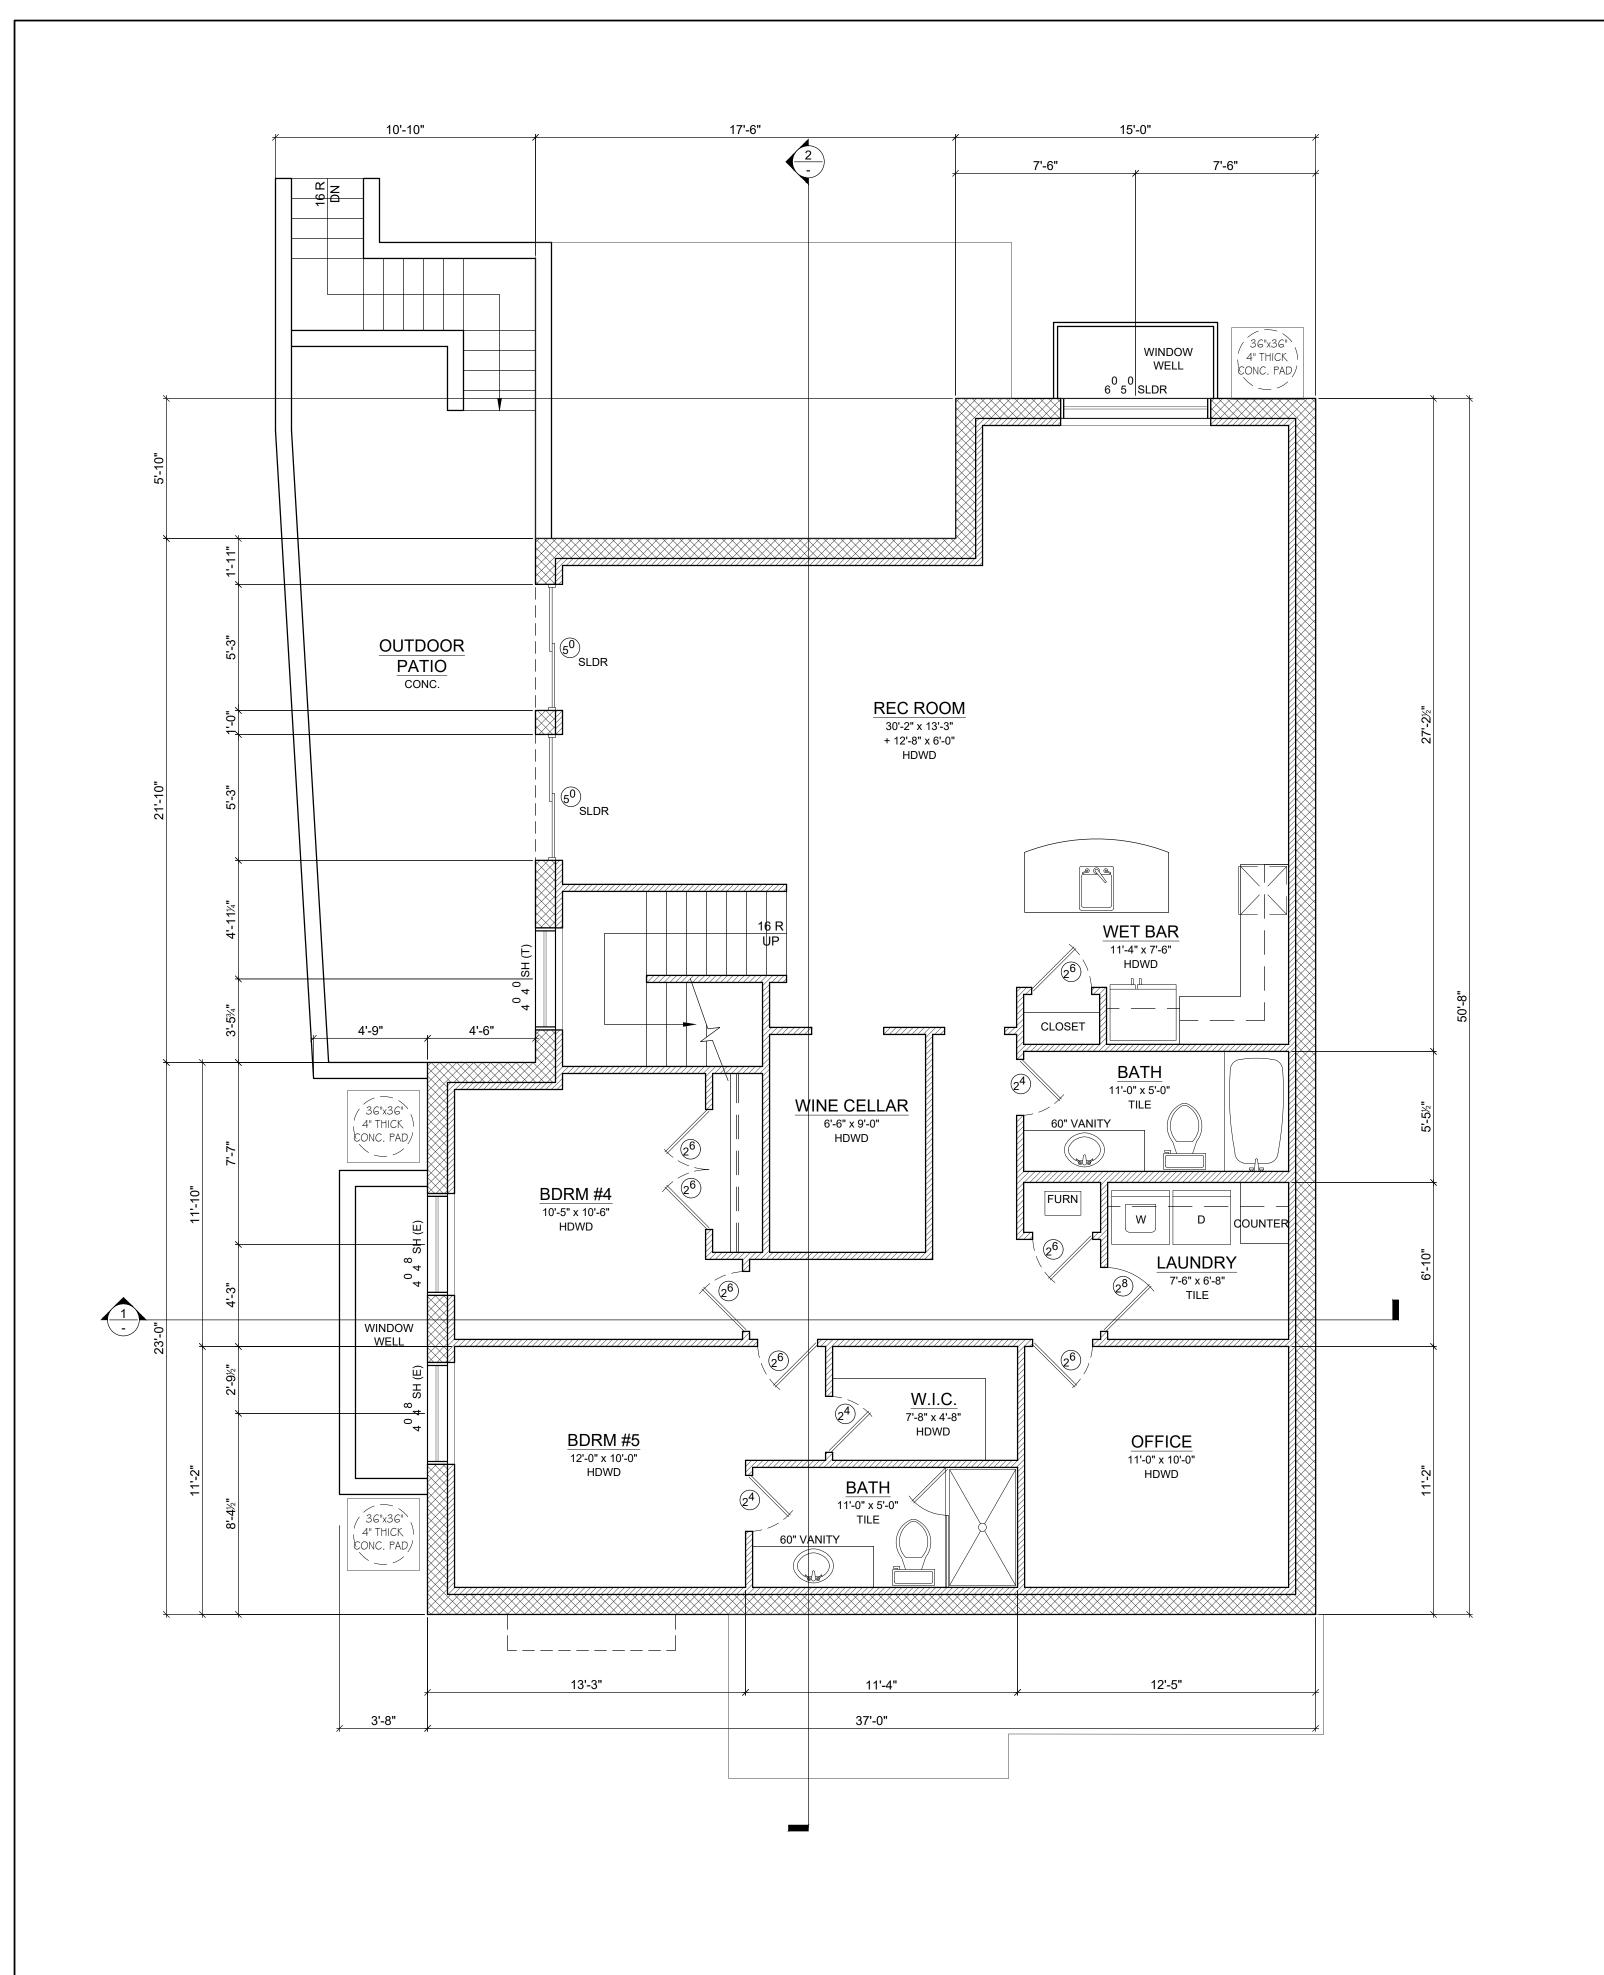SCALE: 1/4" = 1'-0"


ROOF PLAN SCALE: 1/4" = 1'-0"

5/12 SLOPE

CALQUAL - SPEC HOME 566 LINCOLN AVE LOS ALTOS, CA 94022

FRONT ELEVATION

SCALE: 1/4" = 1'-0"

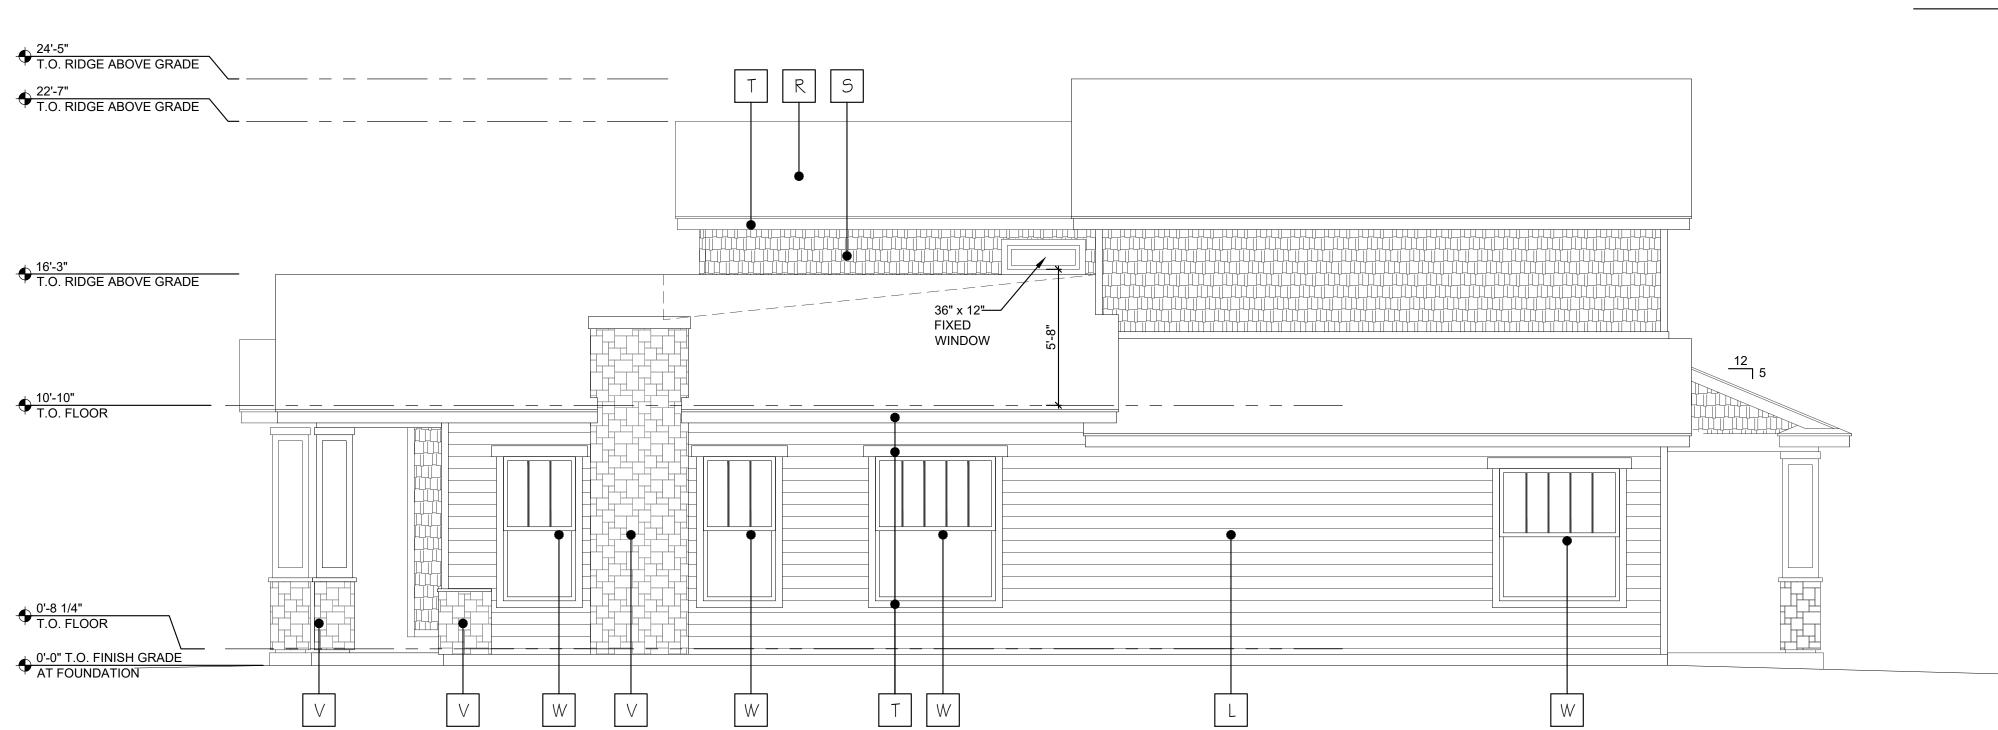

RIGHT ELEVATION

SCALE: 1/4" = 1'-0"

FINISH SCHEDULE




HardieShingle STRAIGHT EDGE PANEL, COLOR TO MATCH "GRAY SLATE"

LOW-E VINYL WINDOWS,

MILGARD "WHITE"

FRAME COLOR TO MATCH

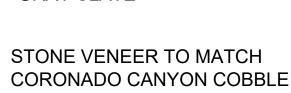

WOOD DOOR, COLOR TO MATCH "MAHOGANY WOOD"





LIGHT WEIGHT CONCRETE ROOF TILE SIMILAR TO EAGLE ROOFING CAPISTRANO STYLE, COLOR "CALABAR BLEND"



HardieTrim, HardieSoffit & GUTTERS, COLOR TO MATCH "ARTIC WHITE"



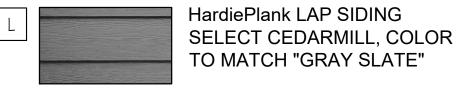

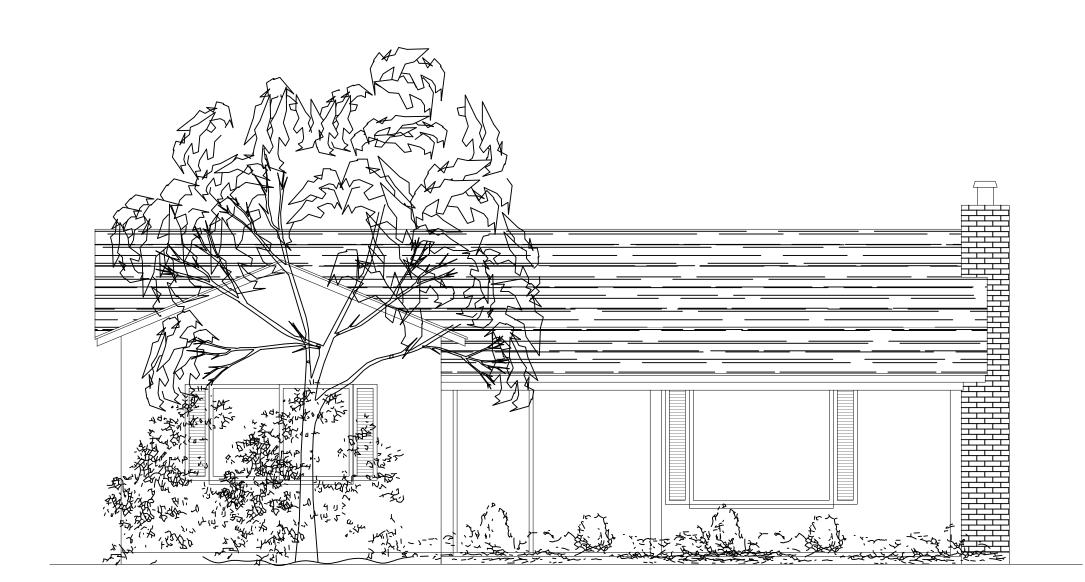

EXISTING STRUCTURE ELEVATION

SCALE: 1/4" = 1'-0"


CALQUAL - SPEC HOME 566 LINCOLN AVE LOS ALTOS, CA 94022

ESIGNER DESIGNER

A3.0A

REAR ELEVATION

SCALE: 1/4" = 1'-0"

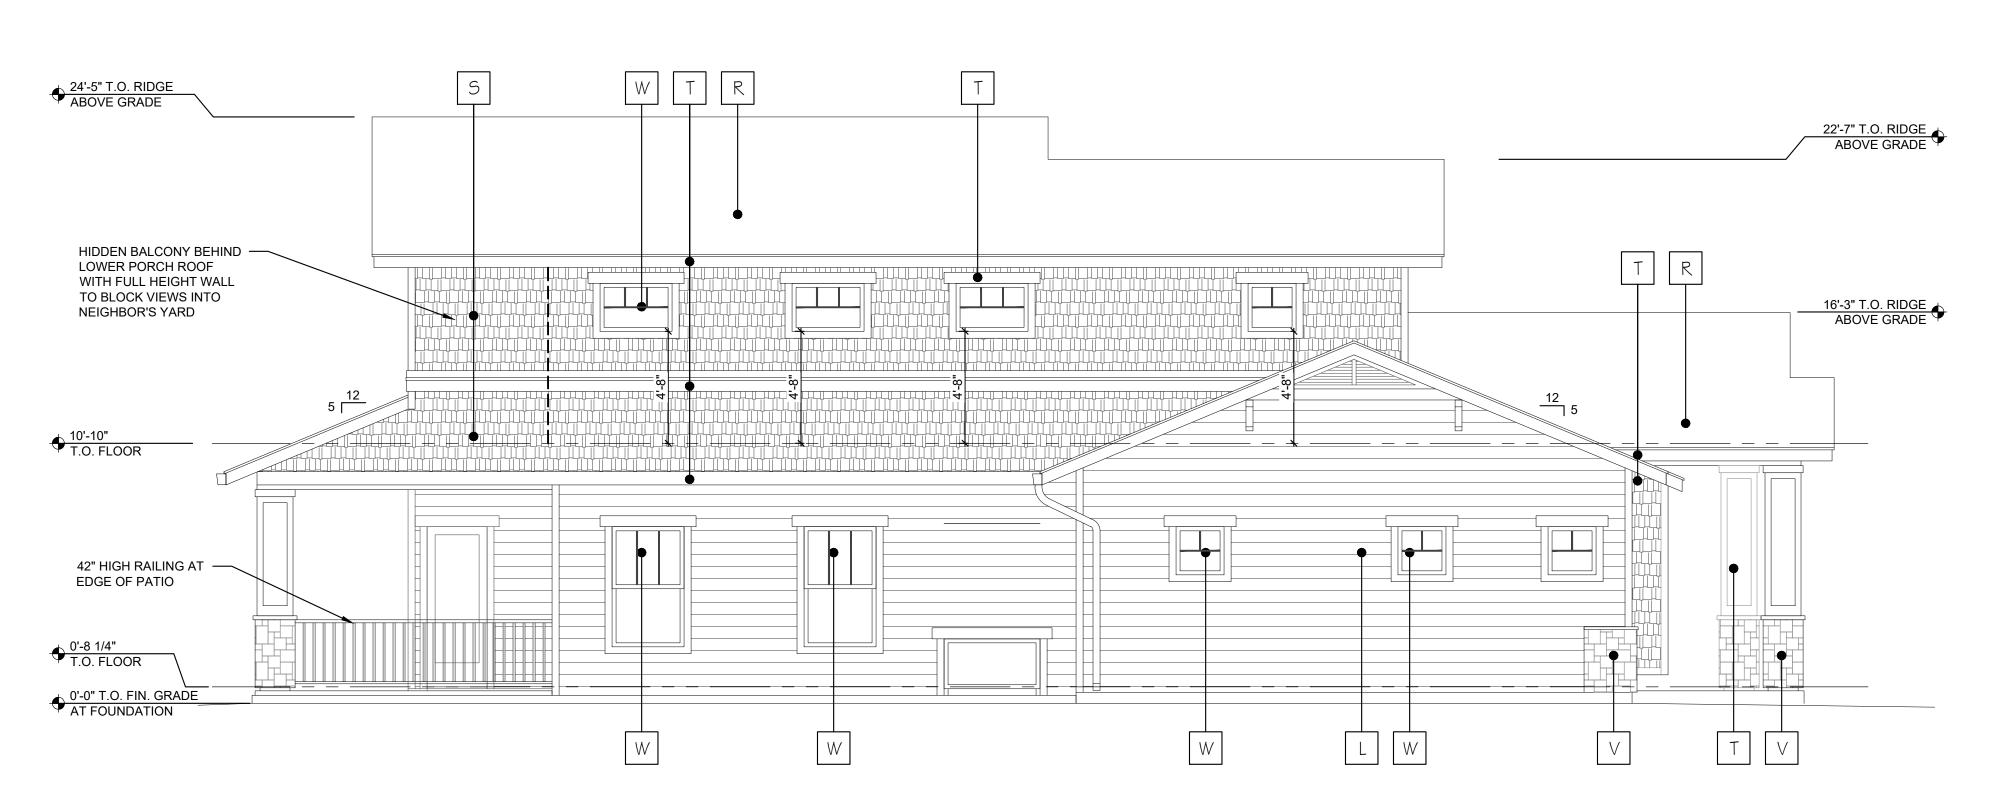

LEFT ELEVATION

SCALE: 1/4" = 1'-0"

FINISH SCHEDULE



HardieShingle STRAIGHT EDGE PANEL, COLOR TO MATCH "GRAY SLATE"



STONE VENEER TO MATCH CORONADO CANYON COBBLE "WIND RIVER"




LOW-E VINYL WINDOWS, FRAME COLOR TO MATCH MILGARD "WHITE"



HardiePlank LAP SIDING SELECT CEDARMILL, COLOR TO MATCH "GRAY SLATE"



WOOD DOOR, COLOR TO MATCH "MAHOGANY WOOD"

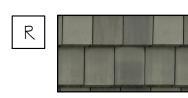

LIGHT WEIGHT CONCRETE ROOF TILE SIMILAR TO EAGLE ROOFING CAPISTRANO STYLE, COLOR "CALABAR BLEND"



HardieTrim, HardieSoffit & GUTTERS, COLOR TO MATCH "ARTIC WHITE"

LIE

BENINTENDI DESIGNER

OPTION ELEVATIONS

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7/1/18 AS NOTED

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A3.0B

FRONT ELEVATION

SCALE: 1/4" = 1'-0"

FINISH SCHEDULE



HardieShingle STRAIGHT EDGE PANEL, COLOR TO MATCH "GRAY SLATE"

STONE VENEER TO MATCH CORONADO CANYON COBBLE

LOW-E VINYL WINDOWS,

MILGARD "WHITE"

FRAME COLOR TO MATCH



WOOD DOOR, COLOR TO MATCH "MAHOGANY WOOD"



LIGHT WEIGHT CONCRETE ROOF TILE SIMILAR TO EAGLE ROOFING CAPISTRANO STYLE, COLOR "CALABAR BLEND"




HardieTrim, HardieSoffit & GUTTERS, COLOR TO MATCH



"ARTIC WHITE"






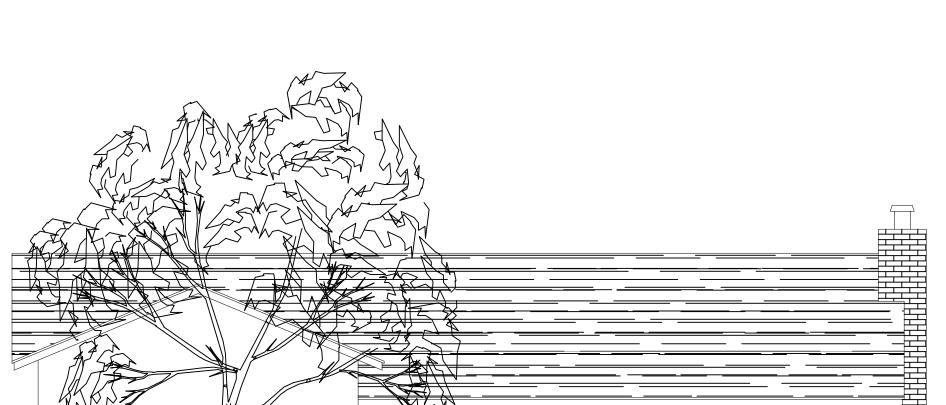

EXISTING STRUCTURE ELEVATION

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RIGHT ELEVATION

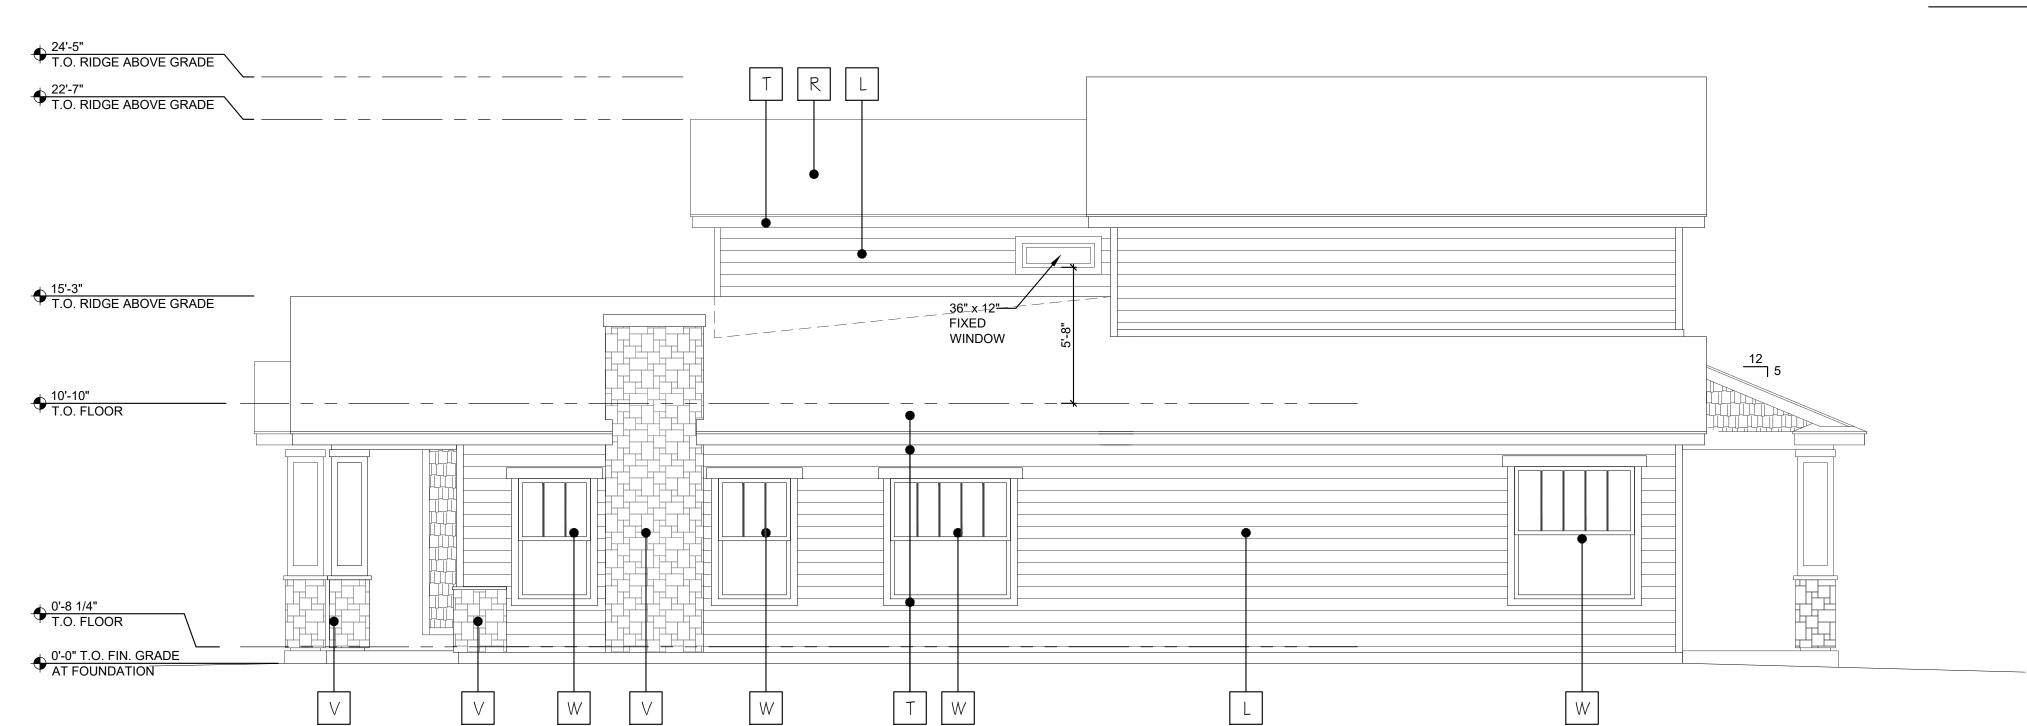
SCALE: 1/4" = 1'-0"

CALQUAL - SPEC HOME 566 LINCOLN AVE LOS ALTOS, CA 94022

BENINTENDI DESIGNER

REAR ELEVATION

SCALE: 1/4" = 1'-0"

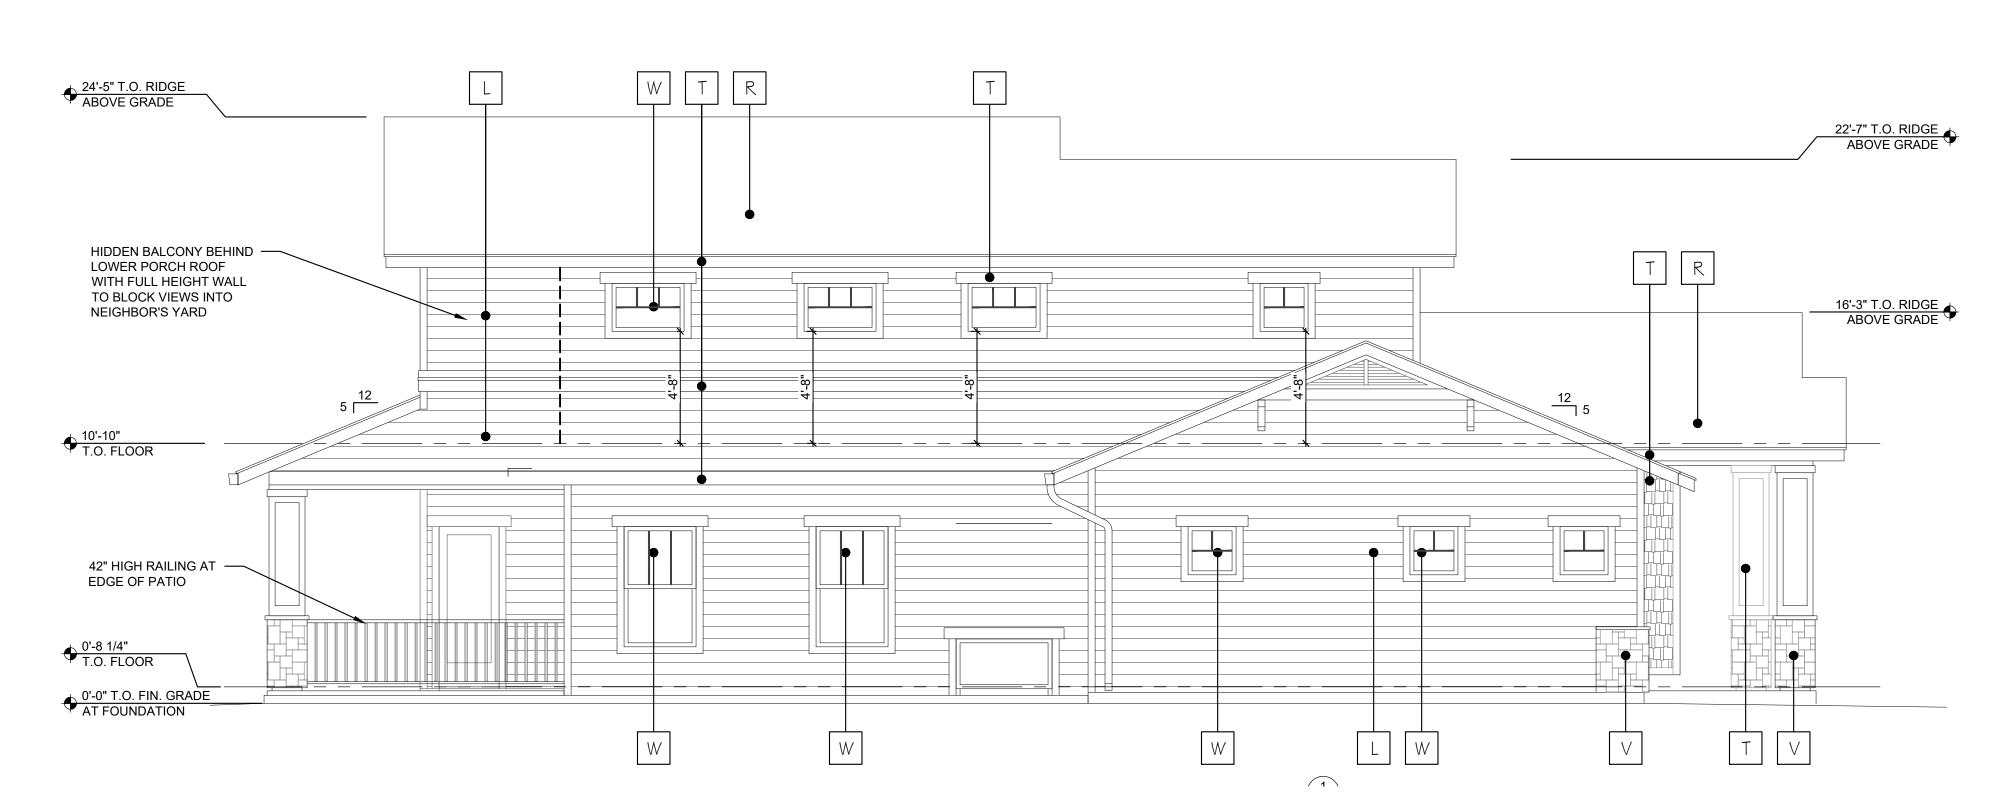

LEFT ELEVATION

SCALE: 1/4" = 1'-0"


FINISH SCHEDULE



HardieShingle STRAIGHT EDGE PANEL, COLOR TO MATCH "GRAY SLATE"



STONE VENEER TO MATCH CORONADO CANYON COBBLE "WIND RIVER"

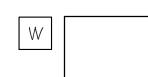

LOW-E VINYL WINDOWS, FRAME COLOR TO MATCH MILGARD "WHITE"



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HardieTrim, HardieSoffit & GUTTERS, COLOR TO MATCH "ARTIC WHITE"

BENINTENDI DESIGNER LIE

OPTION ELEVATIONS

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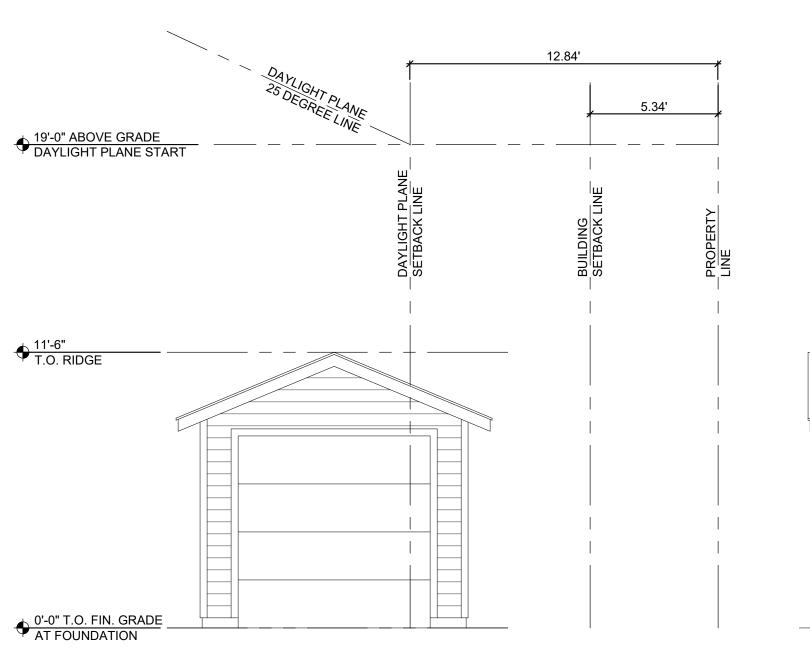
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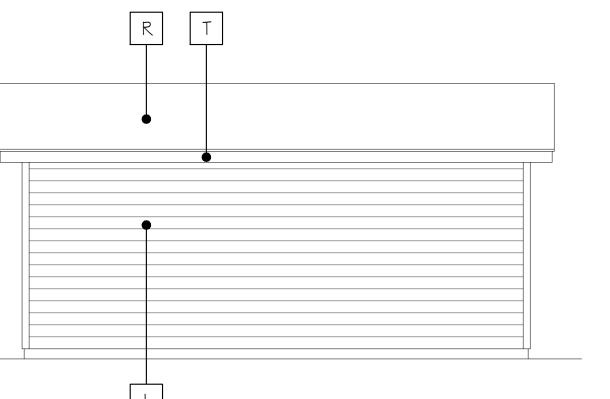
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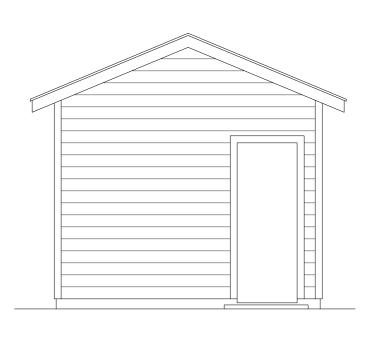
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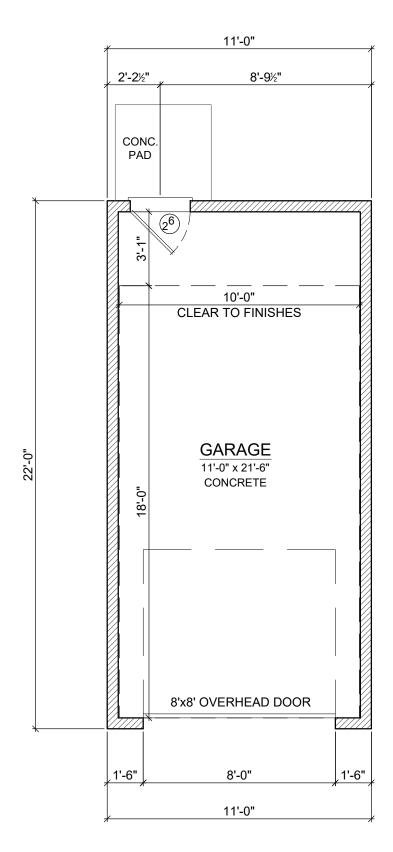







GARAGE ELEVATIONS

SCALE: 1/4" = 1'-0"



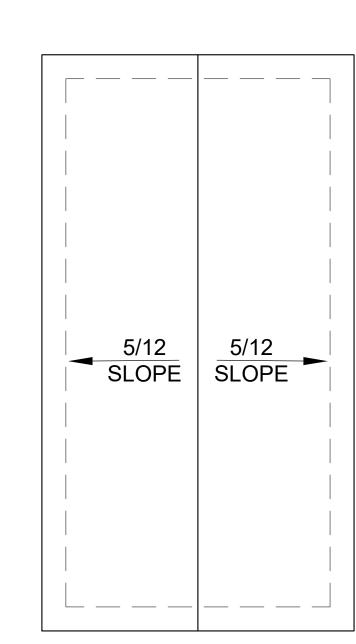

FLOOR PLAN

SCALE: 1/4" = 1'-0"


ROOF PLAN

SCALE: 1/4" = 1'-0"

GARAGE PLANS & ELEVATIONS

CALQUAL - SPEC HOME 566 LINCOLN AVE LOS ALTOS, CA 94022

A4.0

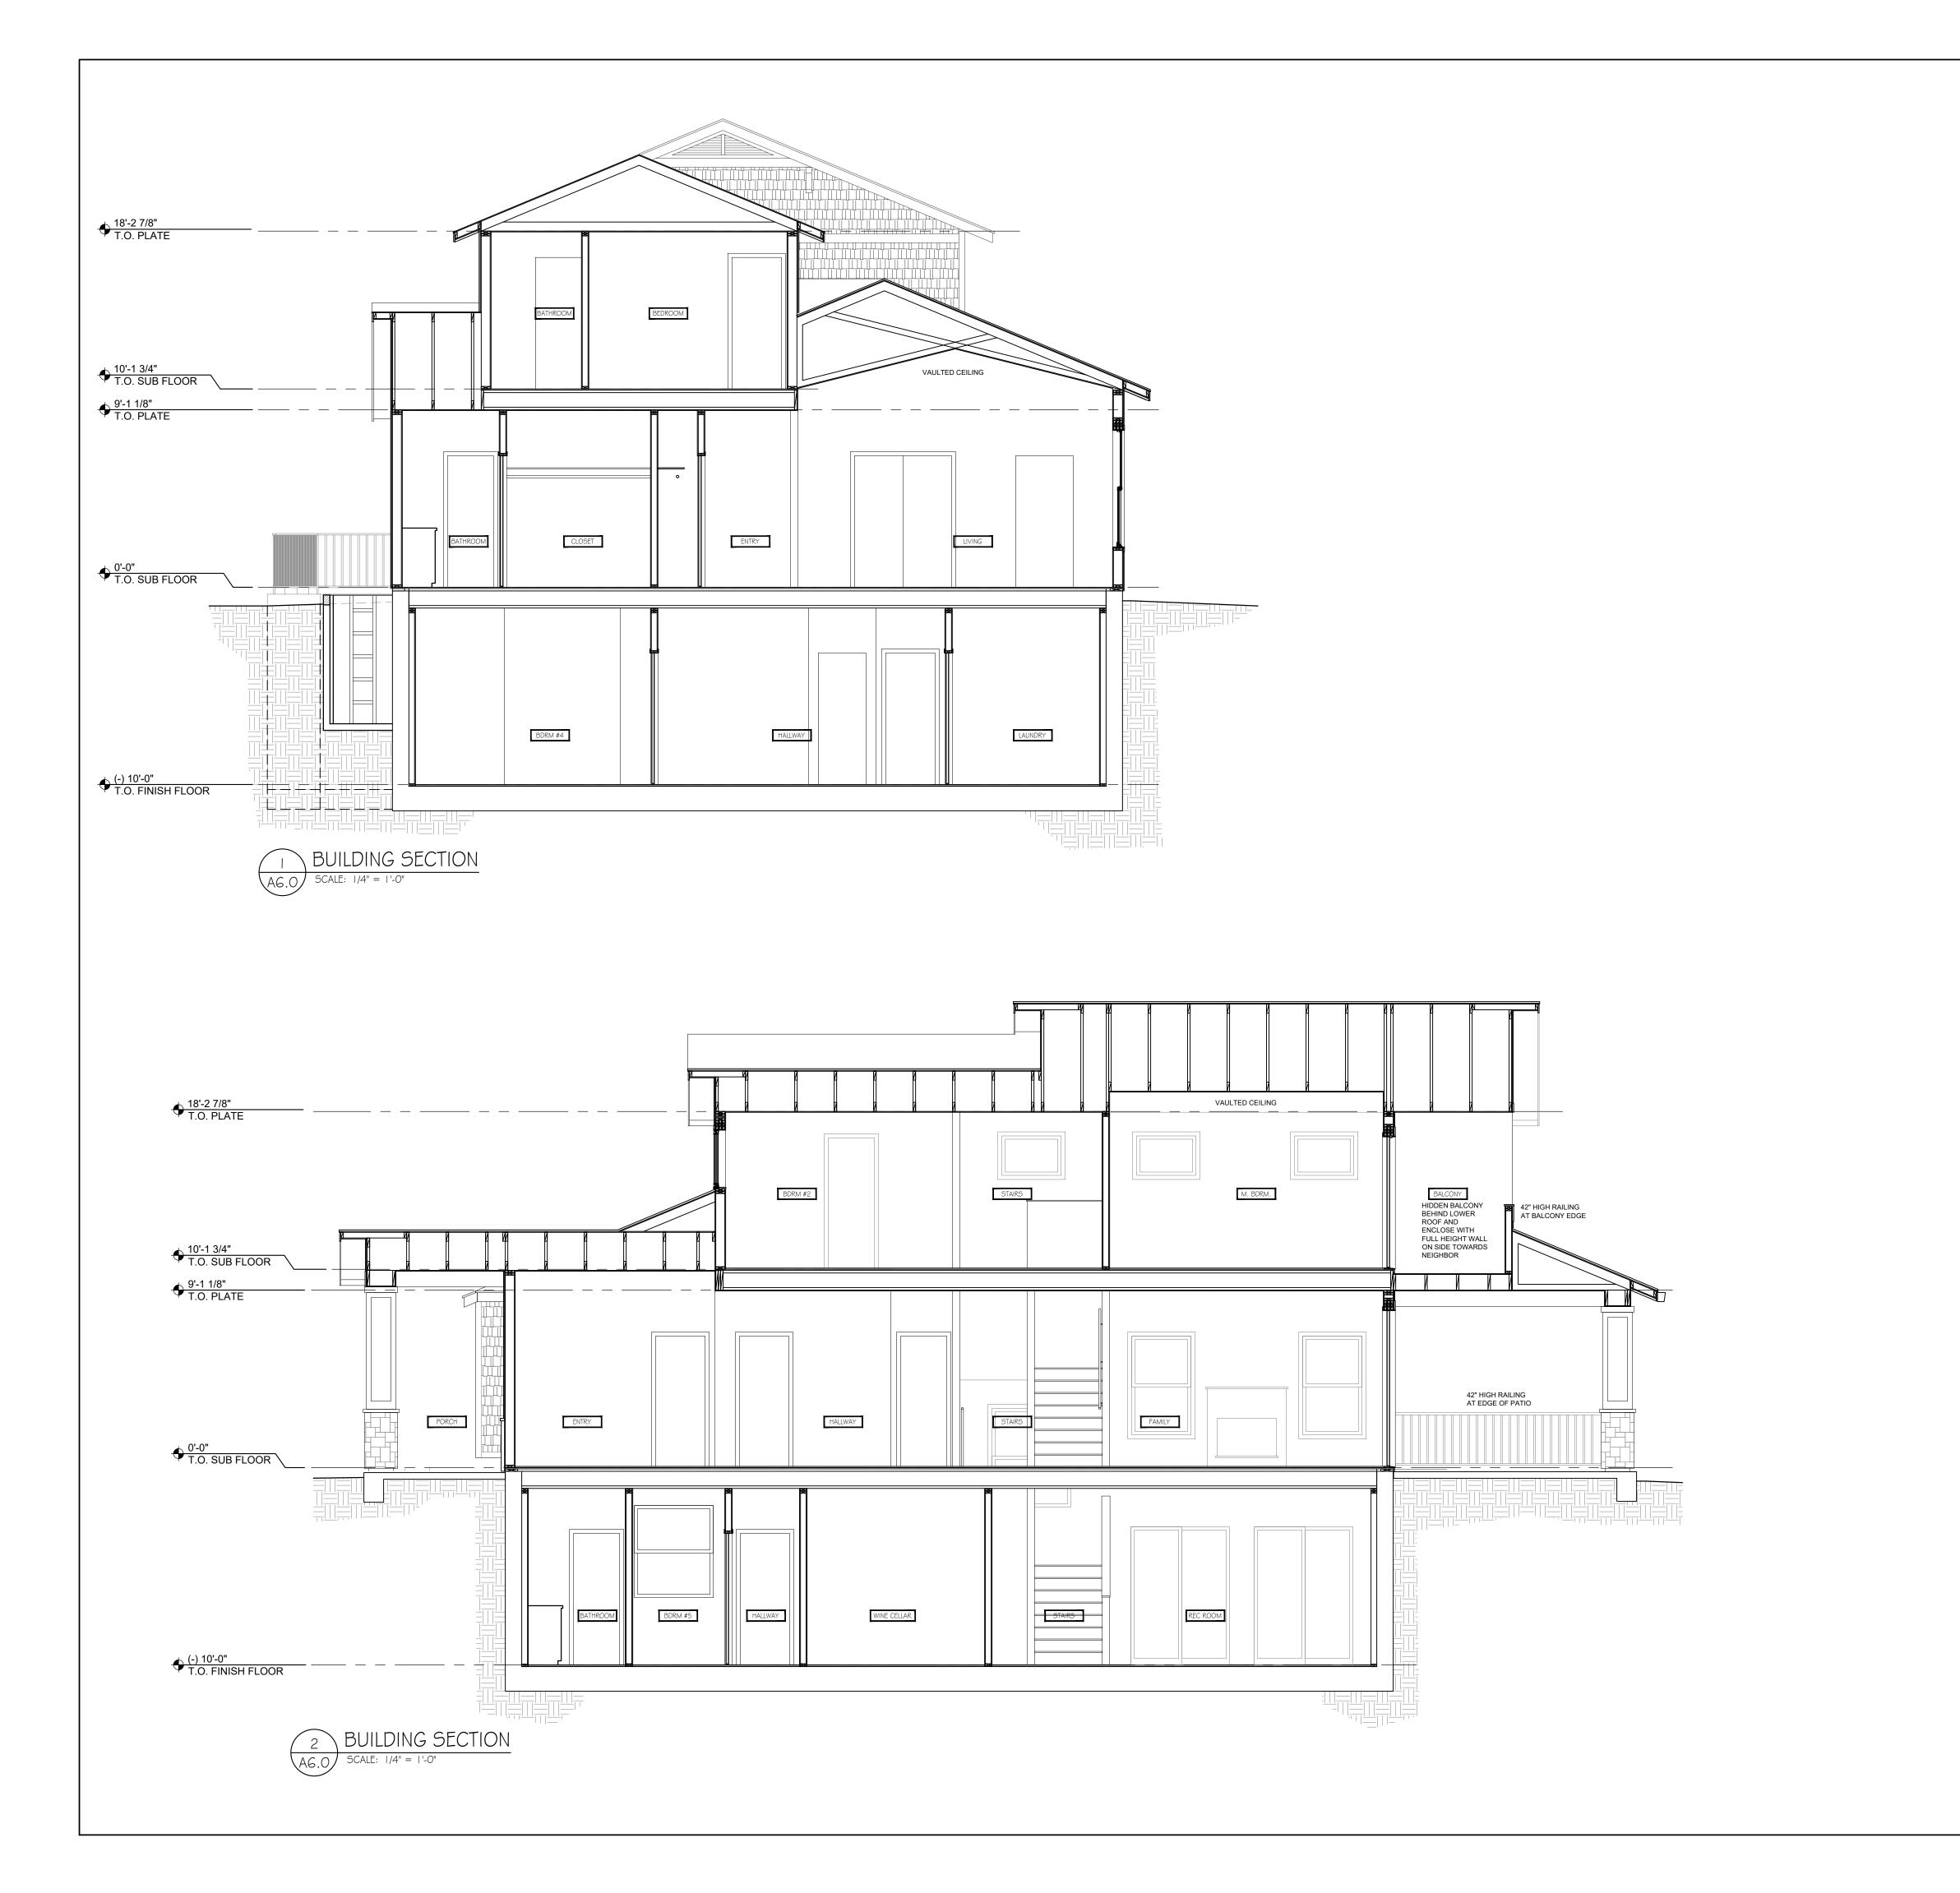

JULIE BENINTENDI DESIGNER

SECTIONS & DETAILS

CALQUAL - SPEC HOME 566 LINCOLN AVE LOS ALTOS, CA 94022 REVISIONS:

7/1/18 AS NOTED Drawn By:

Checked By: 17009